
APPENDIX A

STANDARD MAPS

- A-1 Site Location Map
- A-2 Site Plan Map/Project Footprint
- A-3 Geologic Map
- A-4 USGS Topographic Map
- A-5 Aerial Maps
- A-6 Flood Zones Map
- A-7 National Wetlands Inventory Map

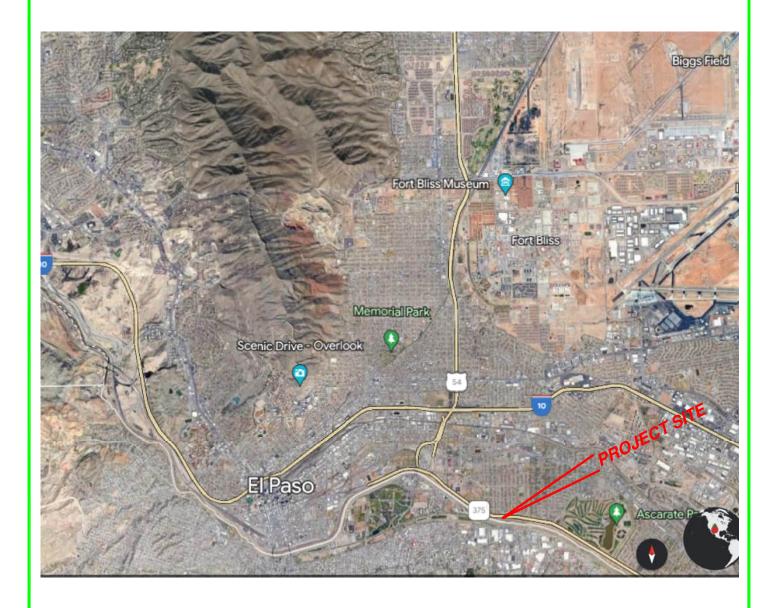





Project No. EPWU 23-13 Date:March 2024 Scale: 1:79428

ESSCO

dwg by:

designed by: ESSCO

Clardy Fox Pump Station Environmental Assessment El Paso, Texas

Site Location Map



Sheet No.







SOURCE: GOOGLE EARTH IMAGE: August 2023



Project No.

EPWU 23-13

Date: March 2024

Scale: 1:2976

Scale: 1:2976

dwg by: ESSCO

designed by: ESSCO


Clardy Fox Pump Station Environmental Assessment El Paso, Texas

Site Plan Map



Sheet No.



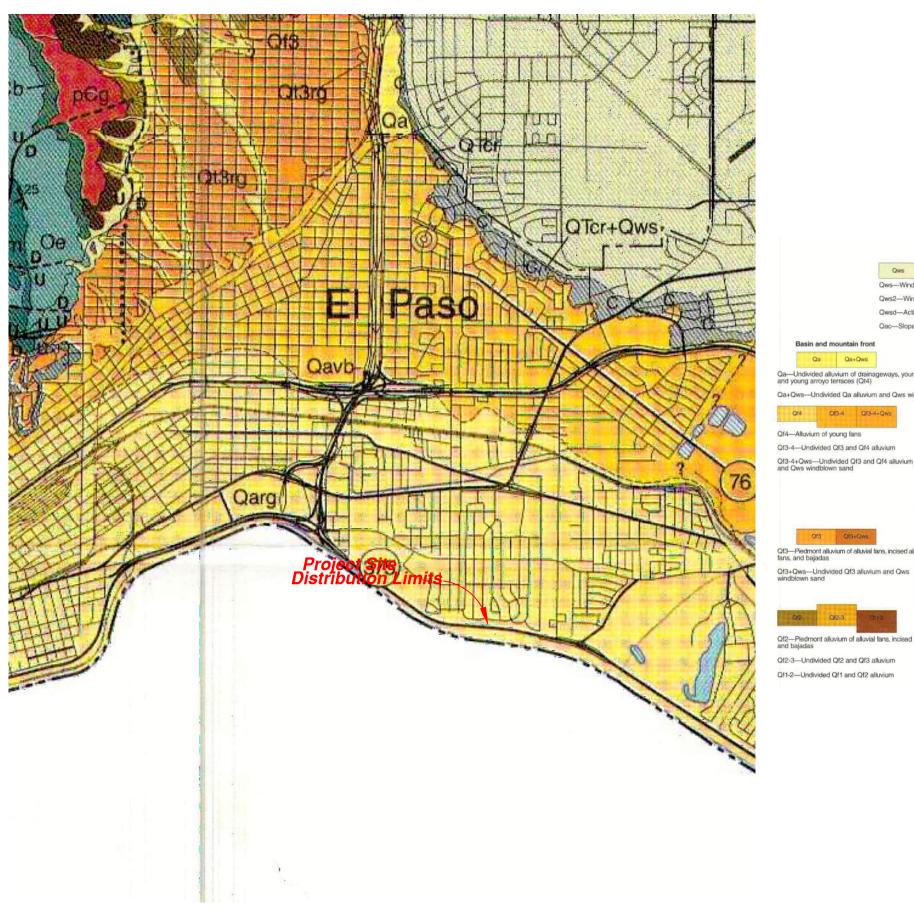

LEGEND

QUATERNARY Holocene-Upper Pleistocene (approximate

Qws-Windblown sand Qws2—Windblown-sand area of partly vegetated, stabilized to partly stabilized dunes Qwsd-Active sand dunes Qac-Slope wash alluvium and/or colluvium Basin and mountain front Rio Grande valley and valley margin Qa Qa+Qws Oarg Qa—Undivided alluvium of drainageways, young fans (Qf4), and young arroyo terraces (Qf4) Qarg-Alluvium of Rio Grande floodplain Qa+Qws-Undivided Qa alluvium and Qws wirdblown sand Q14rg Q14rg+Qws Q14rg+Qws2 Q8vb Qavb+Qws Q14+Qarg Qf4 Qf3-4 Qf3-4-Qws Qt4rg-Alluvium of young terraces and fans along the Rio Grande valley border Qf4—Alluvium of young fans Qt4rg+Qws-Undivided Qt4rg alluvium and Qws windblown sand Qf3-4-Undivided Qf3 and Qf4 alluvium Qt4rg+Qws2—Undivided Qt4rg alluvium and Qws2 windblown sand Qf3-4+Qws—Undivided Qf3 and Qf4 alluvium and Qws windblown sand Qavb—Undivided alluvium of drainageways, young fans, and young arroyo terraces located along the Rio Grande valley border Qavb+Qws---Undivided Qavb alluvium and Qws windblown sand Qf4+Qarg-Undivided Qf4 and Qarg alluvium Upper Pleistocene (approximate) Qf3 Qf3+Qws Qt3—Piedmont alluvium of alluvial fans, incised alluvial fans, and bajadas Qt3rg—Alluvium of terraces and alluvial fans located along Rio Grande valley border

Qt3rg+Qws2—Undivided Qt3rg alluvium and Qws2 windblown sand

Upper Pleistocene to Middle Pleistocene (approximate)

Qt2rg—Alluvium of terraces and alluvial fans along Rio Grande valley border Qf2—Piedmont alluvium of alluvial fans, incised funs, and baladas

Qt2rg+Qws2—Undivided Qt2rg alluvium and Qws2 windblown sand

013

Large arroyo

Qal+Qws

Qal+Qws-Undivided alluvium of large arroyos (Qal) and windblown sand (Qws)

Qt3—Alluvium of terraces within large arro

Qt2 Qt2+Qwe

Qt2—Alluvium of terraces along large arro Qt2+Qws—Undivided Qt2 alluvium and Q windblown sand



FIGURE IS FOR GRAPHICAL REPRESENTATION ONLY.




Environmental Assessment Clardy Fox Pump Station El Paso, Texas Geologic Map

Sheet No.





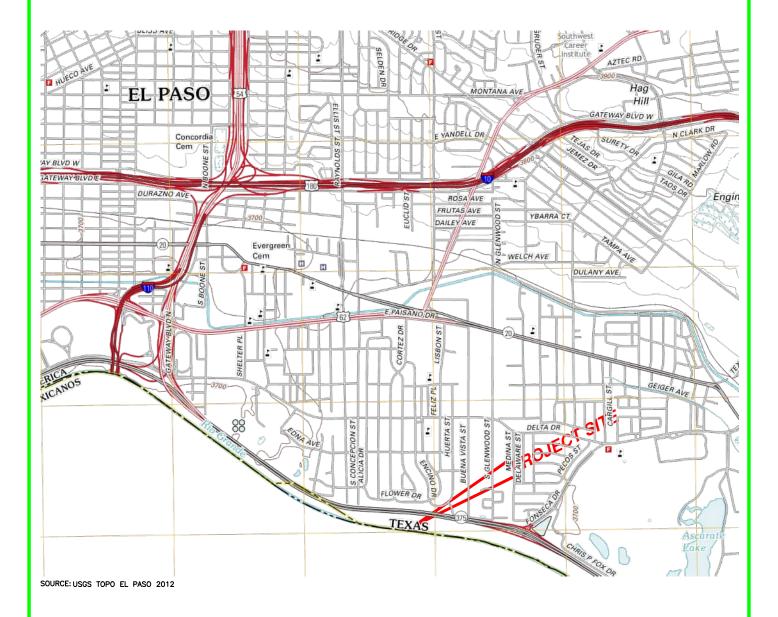



Clardy Fox Pump Station Environmental Assessment El Paso, Texas


Topographic Map



Sheet No.





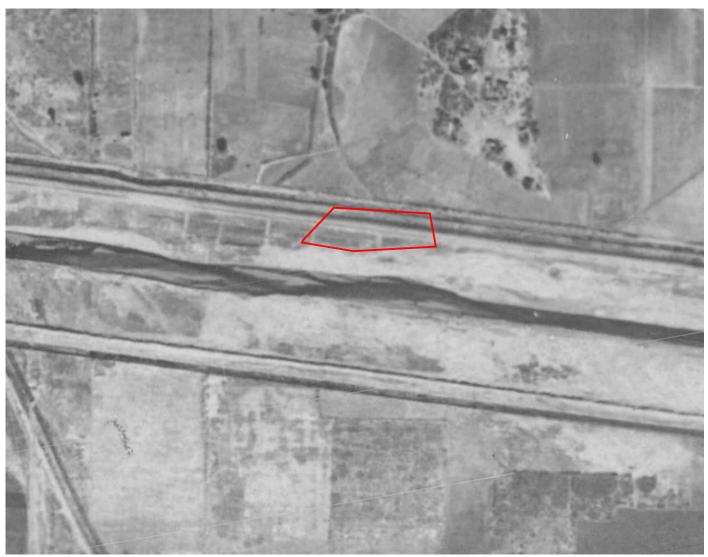



Project No.

EPWU 23-13

Date: March 2024

Scale: 1:6300

dwg by: ESSCO

designed by:
ESSCO

Clardy Fox Pump Station EA El Paso, Texas

Aerial Photograph 1936



Sheet No. **1** OF **11**





Project Site

Project No.

EPWU 23-13

Date: March 2024

Scale: 1:6300

dwg by: ESSCO

designed by: ESSCO Clardy Fox Pump Station EA El Paso, Texas

Aerial Photograph 1946



Sheet No.

2 OF 11







Project No.

EPWU 23-13

Date:March 2024

Scale: 1:6300

dwg by: ESSCO
designed by: ESSCO

Clardy Fox Pump Station EA El Paso, Texas

Aerial Photograph 1956









Project No.
EPWU 23-13
Date: March 2024

dwg by: ESSCO
designed by: ESSCO

Clardy Fox Pump Station EA El Paso, Texas Aerial Photograph

Aerial Photograph 1967



Sheet No.







Project No.

EPWU 23-13

Date:March 2024

Scale: 1:6300

dwg by: ESSCO
designed by: ESSCO

Clardy Fox Pump Station EA El Paso, Texas

Aerial Photograph 1974



Sheet No.







Project No.

EPWU 23-13

Date: March 2024

Scale: 1:6300

dwg by: ESSC0
designed by: ESSC0

Clardy Fox Pump Station EA El Paso, Texas

Aerial Photograph 1984



Sheet No.





Project Site

Project No.

EPWU 23-13

Date: March 2024

Scale: 1:6300

dwg by: ESSCO

designed by: ESSCO Clardy Fox Pump Station EA EI Paso, Texas Aerial Photograph 1995 ESSCO 1000 Newman St. El Paso, Texas 79902 Pr. (915) 533-1102 Pr. (915) 533-1103

Sheet No.





/ Project Site

Project No.

EPWU 23-13

Date: March 2024

Scale: 1:6300

dwg by: ESSCO
designed by: ESSCO

Clardy Fox Pump Station EA El Paso, Texas

Aerial Photograph 2004



Sheet No.





Project Site

Project No.

EPWU 23-13

Date: March 2024

Scale: 1:6300

dwg by: ESSCO
designed by: ESSCO

Clardy Fox Pump Station EA El Paso, Texas

Aerial Photograph 2010



Sheet No. **9** OF **11**





Project Site

Project No. EPWU 23-13 Date:March 2024 Scale: 1:6300

dwg by: designed by: ESSCO Clardy Fox Pump Station EA El Paso, Texas

Aerial Photograph 2016



Sheet No.





/ Project Site

Project No.

EPWU 23-13

Date: March 2024

Scale: 1:6300

dwg by: ESSC0
designed by: ESSC0


Clardy Fox Pump Station EA El Paso, Texas

Aerial Photograph 2022



Sheet No.



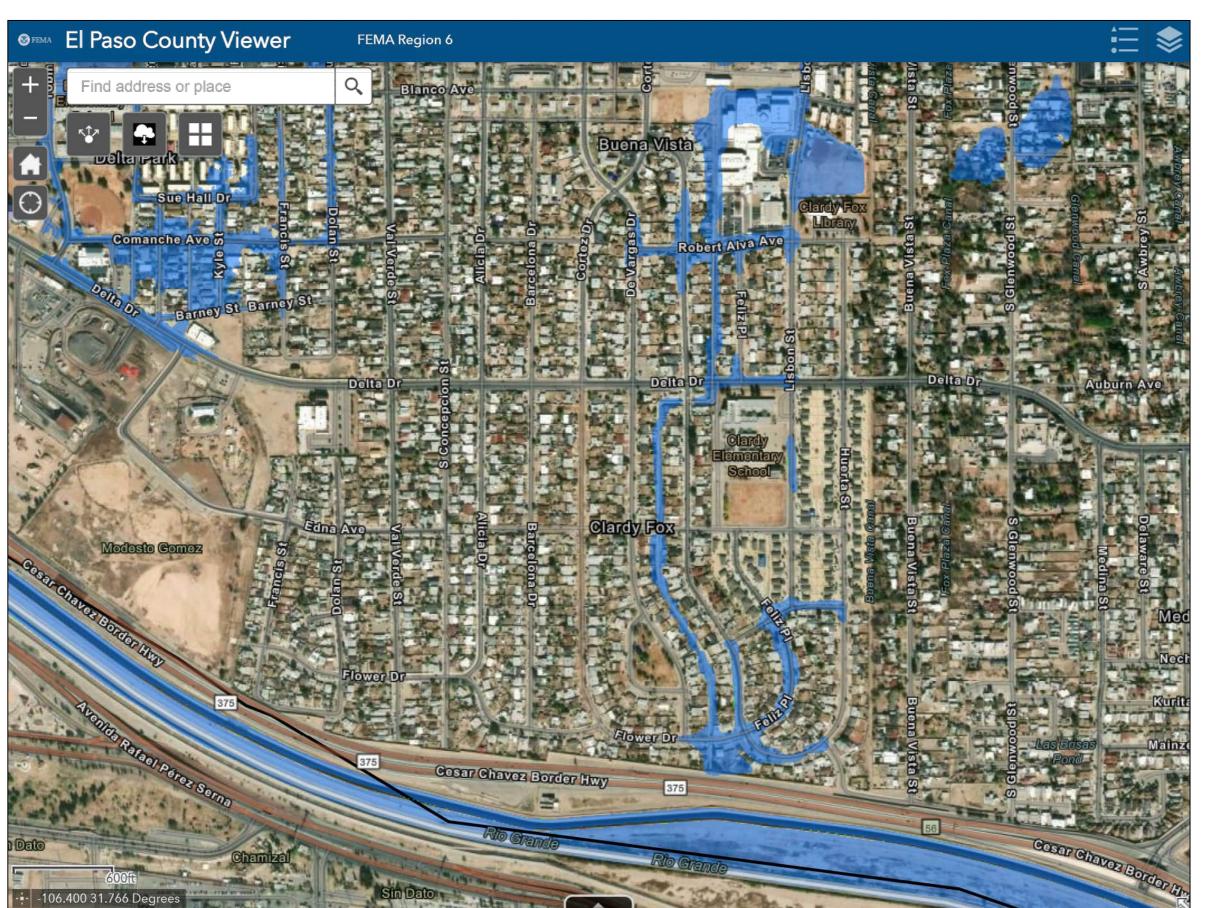






Environmental Assessment Clardy Fox Pump Station El Paso, Texas

Zones Map

REVISIONS

Sheet No.

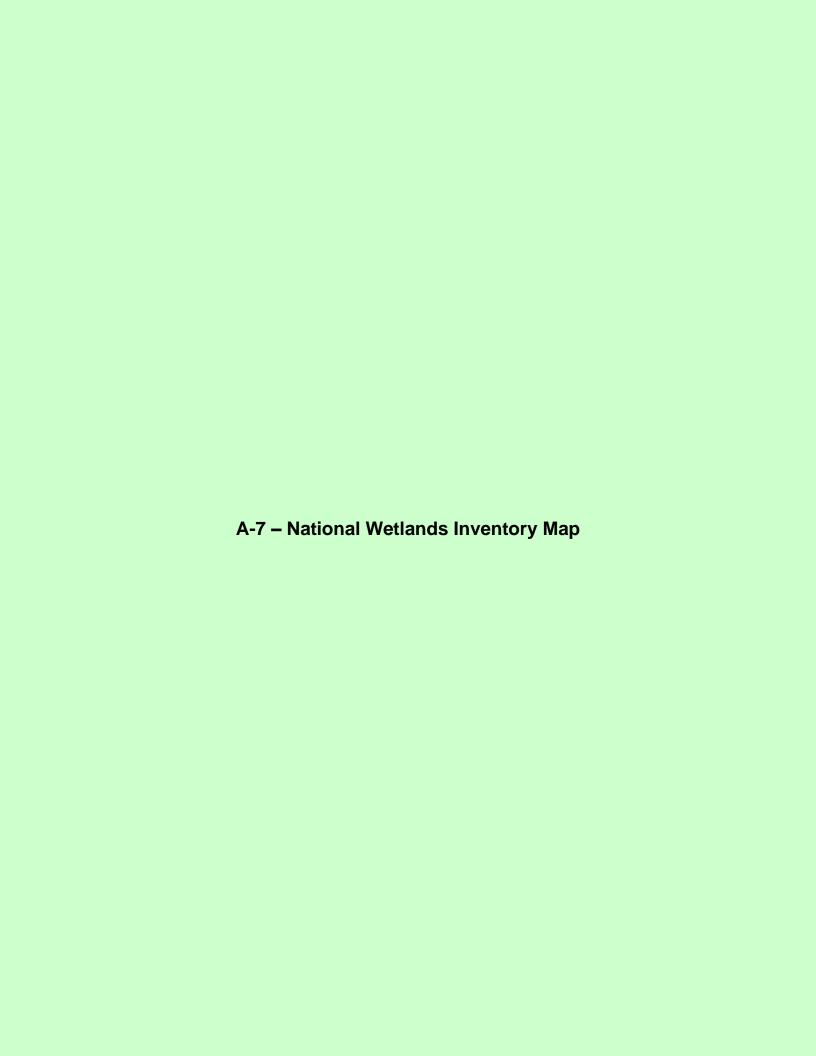

U.S. Fish and Wildlife Service

National Wetlands Inventory

Clardy Fox Pump Station





National Wetlands Map

Revisions

Sheet No.

A - 7



March 12, 2024

Wetlands

Estuarine and Marine Deepwater

Estuarine and Marine Wetland

Freshwater Emergent Wetland

Freshwater Pond

Freshwater Forested/Shrub Wetland

Riverine

Lake


This map is for general reference only. The US Fish and Wildlife Service is not responsible for the accuracy or currentness of the base data shown on this map. All wetlands related data should be used in accordance with the layer metadata found on the


> National Wetlands Inventory (NWI) This page was produced by the NWI mapper

APPENDIX B

ENVIRONMENTAL SETTING AND IMPACTS ATTACHMENTS

- **B-1 NRCS Soil Survey & Prime and Important Farmland**
- **B-2 Photographic Documentation**
- **B-3 Cultural Resources**
- B-4 U.S. Fish and Wildlife Service Information for Planning and Consultation (IPaC) Report
- **B-5 Biological Resources**
- **B-6 Banks Environmental Database**
- **B-7 Public Review**
- **B-8 Contacted Agencies**

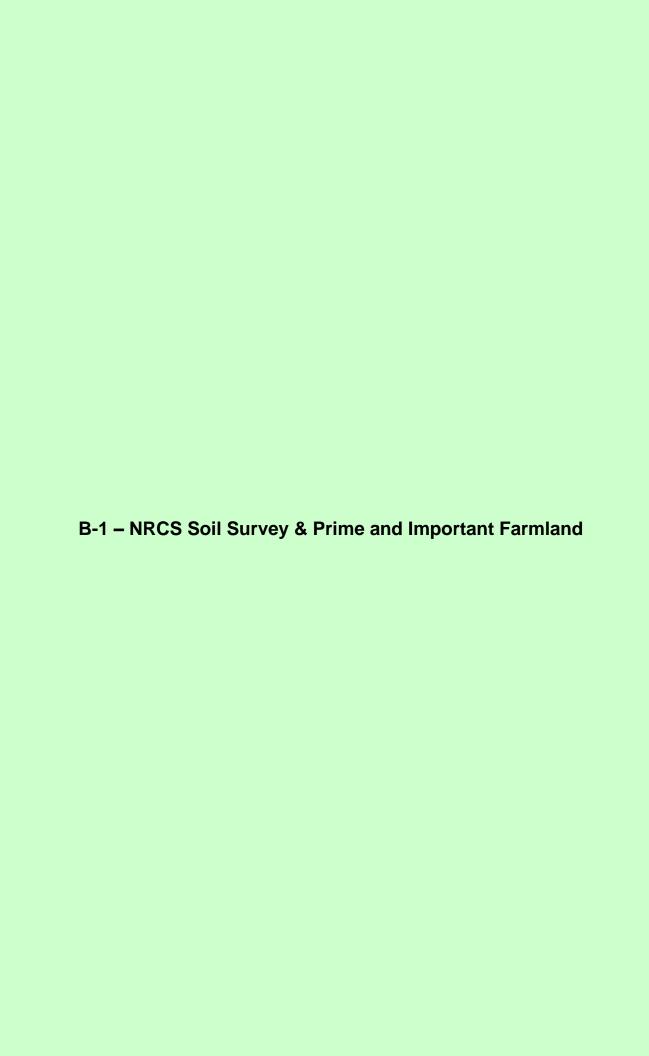

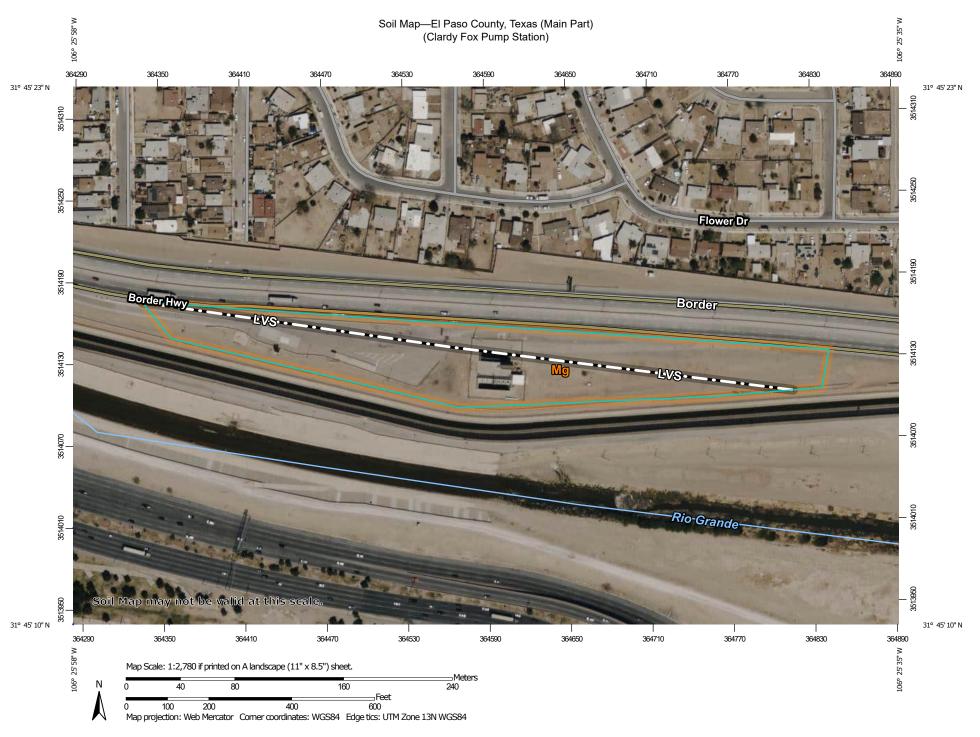

MAP LEGEND

Area of Interest (AOI)

Area of Interest (AOI)

Soils

Soil Map Unit Polygons



Soil Map Unit Lines



Soil Map Unit Points

Special Point Features

Blowout



Borrow Pit



Clay Spot



Closed Depression



Gravel Pit



Gravelly Spot



Landfill



Lava Flow

Marsh or swamp



Mine or Quarry



Miscellaneous Water



Perennial Water



Rock Outcrop



Saline Spot Sandy Spot



Severely Eroded Spot



Sinkhole



Slide or Slip



Sodic Spot



Spoil Area Stony Spot



Very Stony Spot



Wet Spot Other



Special Line Features

Water Features



Streams and Canals

Transportation



Rails



Interstate Highways



US Routes



Major Roads



Local Roads

Background



Aerial Photography

MAP INFORMATION

The soil surveys that comprise your AOI were mapped at 1:31.700.

Warning: Soil Map may not be valid at this scale.

Enlargement of maps beyond the scale of mapping can cause misunderstanding of the detail of mapping and accuracy of soil line placement. The maps do not show the small areas of contrasting soils that could have been shown at a more detailed scale

Please rely on the bar scale on each map sheet for map measurements.

Source of Map: Natural Resources Conservation Service Web Soil Survey URL:

Coordinate System: Web Mercator (EPSG:3857)

Maps from the Web Soil Survey are based on the Web Mercator projection, which preserves direction and shape but distorts distance and area. A projection that preserves area, such as the Albers equal-area conic projection, should be used if more accurate calculations of distance or area are required.

This product is generated from the USDA-NRCS certified data as of the version date(s) listed below.

Soil Survey Area: El Paso County, Texas (Main Part) Survey Area Data: Version 22, Sep 5, 2023


Soil map units are labeled (as space allows) for map scales 1:50.000 or larger.


Date(s) aerial images were photographed: Apr 3, 2021—Apr 4, 2021

The orthophoto or other base map on which the soil lines were compiled and digitized probably differs from the background imagery displayed on these maps. As a result, some minor shifting of map unit boundaries may be evident.

Map Unit Legend

| Map Unit Symbol | Map Unit Name | Acres in AOI | Percent of AOI |
|-----------------------------|-------------------------------|--------------|----------------|
| Mg | Made land, gila soil material | 5.4 | 100.0% |
| Totals for Area of Interest | | 5.4 | 100.0% |

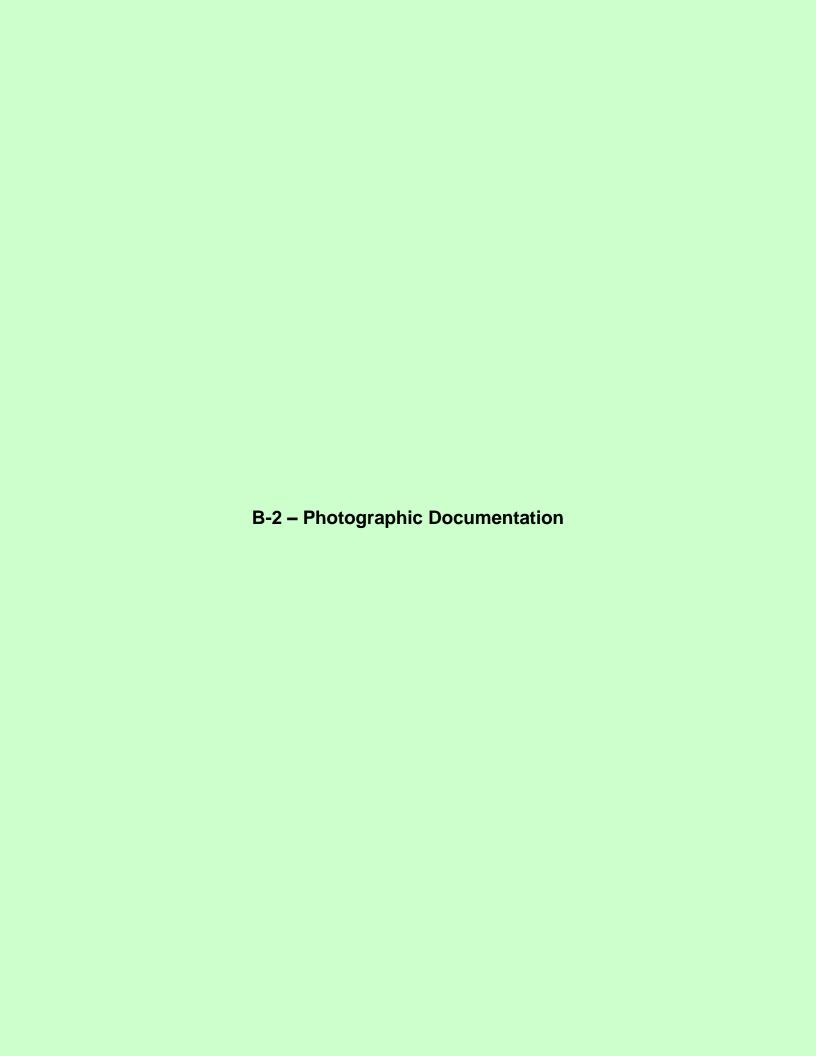

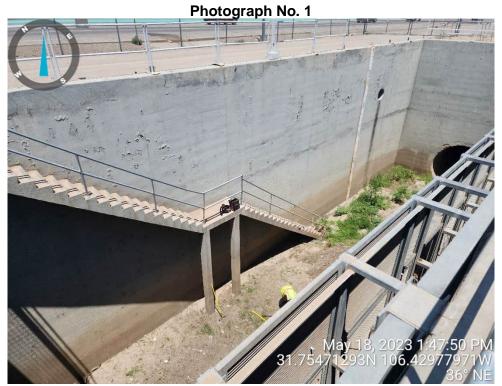


View showing staircase leading to lower portion of Project Site.



View showing staircase leading to upper portion of Project Site.



View showing lower portion of Project Site with Border Highway beyond from the west.

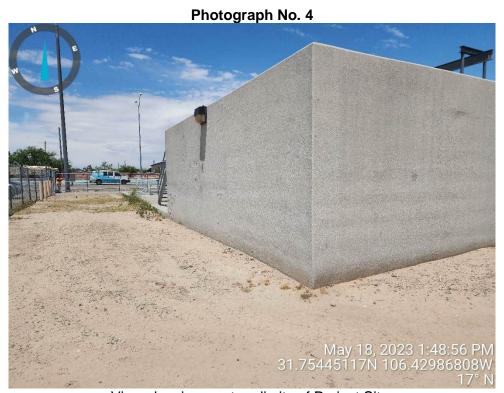

View showing western limits of Project Site.

Photograph No. 5



View showing southern limits of Project Site.

Photograph No. 6



View showing southeastern portion of Project Site.



View showing eastern limits of Project Site.



View looking into lower portion of Project Site from the east.





Clardy Fox Pump Station

2 messages

noreply@thc.state.tx.us <noreply@thc.state.tx.us>
To: zholguin@esscogroup.org, reviews@thc.state.tx.us

Fri, Apr 26, 2024 at 3:00 PM



Re: Project Review under Section 106 of the National Historic Preservation Act

THC Tracking #202407870

Date: 04/26/2024

Clardy Fox Pump Station

TX Loop 375 El Paso,TX 79905

Description: The project involves installing three pumps and associated controls and housing to the existing pump station.

Dear Zakk Holguin:

Thank you for your submittal regarding the above-referenced project. This response represents the comments of the State Historic Preservation Officer, the Executive Director of the Texas Historical Commission (THC), pursuant to review under Section 106 of the National Historic Preservation Act.

The review staff, led by Caitlin Brashear, Drew Sitters and Patrick Bassett, has completed its review and has made the following determinations based on the information submitted for review:

Above-Ground Resources

- Property/properties are eligible for listing or already listed in the National Register of Historic Places.
- No adverse effects on historic properties provided that the following conditions are met.

Archeology Comments

• No historic properties affected. However, if cultural materials are encountered during construction or disturbance activities, work should cease in the immediate area; work can continue where no cultural materials are present. Please contact the THC's Archeology Division at 512-463-6096 to consult on further actions that may be necessary to protect the cultural remains.

We have the following comments: The Texas Historical Commission Division of Architecture review staff, led by Patrick Bassett, has determined that there will be no adverse effect with the condition that ESSCO sends us copies of the design for this infrastructure or related improvements as they are created.

We look forward to further consultation with your office and hope to maintain a partnership that will foster effective historic preservation. Thank you for your cooperation in this review process, and for your efforts to preserve the irreplaceable heritage of Texas. If the project changes, or if new historic properties are found, please contact the review staff. If you have any questions concerning our review or if we can be of further assistance, please email the following reviewers: caitlin.brashear@thc.texas.gov, drew.sitters@thc.texas.gov, patrick.bassett@thc.texas.gov.

This response has been sent through the electronic THC review and compliance system (eTRAC). Submitting your project via eTRAC eliminates mailing delays and allows you to check the status of the review, receive an electronic response, and generate reports on your submissions. For more information, visit http://thc.texas.gov/etrac-system.

Sincerely,

for Bradford Patterson Chief Deputy State Historic Preservation Officer

Patrice Bussett

Please do not respond to this email.

B-4 – U.S. Fish and Wildlife Service Information for Planning and Consultation (IPaC) Report

Regulatory review

The IPaC regulatory review process helps you to evaluate the potential impacts of your project on resources managed by the U.S. Fish and Wildlife Service. It walks you through the regulations that cover each protected resource and offers suggestions and assistance in designing your project.



Endangered species

Endangered species are protected under the Endangered Species Act $\frac{1}{2}$.



Migratory birds

Certain birds are protected under the Migratory Bird Treaty Act³ and the Bald and Golden Eagle Protection Act $\frac{4}{3}$.

10 migratory birds of conservation concern are expected to occur or may be affected by activities in this location.

Contact the local U.S. Fish and Wildlife Service field office There is currently no regulatory review process in IPaC for migratory birds. Please contact the local U.S. Fish and Wildlife Service field office to evaluate effects and authorize take.



🌲 Coastal Barriers

Projects within the Coastal Barrier Resource System may be subject to regulation under the Coastal Barrier Resources Act^{11} , or other State/Federal statutes.

THERE ARE NO KNOWN COASTAL BARRIERS AT THIS LOCATION.

Facilities

U.S. Fish and Wildlife Service facilities are protected under the National Wildlife Refuge System Administration Act⁸ and the National Fish Hatchery System⁹.

THERE ARE NO U.S. FISH AND WILDLIFE SERVICE REFUGES OR FISH HATCHERIES AT THIS LOCATION.



Wetlands

Wetlands and other aquatic habitats may be subject to regulation under Section 404 of the Clean Water Act^{10} , or other State/Federal statutes.

THIS LOCATION DID NOT INTERSECT ANY WETLANDS MAPPED BY NWI.

- 1. The Endangered Species Act (ESA) of 1973.
- 2. The <u>Migratory Birds Treaty Act</u> of 1918.
- 3. The Bald and Golden Eagle Protection Act of 1940.
- 4. NOAA Fisheries, also known as the National Marine Fisheries Service (NMFS), is an office of the National Oceanic and Atmospheric Administration within the Department of Commerce.
- 5. The National Wildlife Refuge System Administration Act of 1966.
- 6. The National Fish Hatchery System.
- 7. <u>Section 404 of the Clean Water Act</u> establishes a program to regulate the discharge of dredged and fill material into waters of the United States, including wetlands.
- 8. The Coastal Barrier Resources Act.



El Paso Water Clardy Fox Pump Station Project (TPWD #51684)

Richard Hanson < Richard. Hanson@tpwd.texas.gov>

Tue 3/5/2024 7:34 AM

To:ypereyra@esscogroup.org <ypereyra@esscogroup.org> Hi Yvette,

Thank you for submitting the proposed Clardy Fox Pump Station project for review. Based on review of the documentation and description provided, the Environmental Review Team does not anticipate significant adverse impacts to rare, threatened, or endangered species, or other fish and wildlife resources. However, please note it is the responsibility of the project proponent to comply with all federal, state, and local laws that protect fish and wildlife. Provided the project plans do not change, TPWD considers coordination to be complete.

Rick Hanson
Environmental Review Biologist
Ecological & Environmental Planning Program
Texas Parks & Wildlife Department
(806) 761-4930 ext. 4936



Life's better outside.®

Last Update: 9/1/2023

EL PASO COUNTY

AMPHIBIANS

Woodhouse's toad Anaxyrus woodhousii

Terrestrial and aquatic: A wide variety of terrestrial habitats are used by this species, including forests, grasslands, and barrier island sand dunes.

Aquatic habitats are equally varied.

Federal Status: State Status: SGCN: Y
Endemic: N Global Rank: G5 State Rank: SU

BIRDS

chestnut-collared longspur Calcarius ornatus

Occurs in open shortgrass settings especially in patches with some bare ground. Also occurs in grain sorghum fields and Conservation Reserve

Program lands

Federal Status: State Status: SGCN: Y
Endemic: N Global Rank: G5 State Rank: S3

Franklin's gull Leucophaeus pipixcan

The county distribution for this species includes geographic areas that the species may use during migration. Time of year should be factored into evaluations to determine potential presence of this species in a specific county. This species is only a spring and fall migrant throughout Texas. It does not breed in or near Texas. Winter records are unusual consisting of one or a few individuals at a given site (especially along the Gulf coastline). During migration, these gulls fly during daylight hours but often come down to wetlands, lake shore, or islands to roost for the night.

Federal Status: State Status: SGCN: Y

Endemic: N Global Rank: G5 State Rank: S2N

golden eagle Aquila chrysaetos

Habitat description is not available at this time.

Federal Status: State Status: SGCN: Y

Endemic: N Global Rank: G5 State Rank: S3B

lark bunting Calamospiza melanocorys

Overall, it's a generalist in most short grassland settings including ones with some brushy component plus certain agricultural lands that include grain sorghum. Short grasses include sideoats and blue gramas, sand dropseed, prairie junegrass (Koeleria), buffalograss also with patches of bluestem and other mid-grass species. This bunting will frequent smaller patches of grasses or disturbed patches of grasses including rural yards. It also uses weedy fields surrounding playas. This species avoids urban areas and cotton fields.

Federal Status: State Status: SGCN: Y

Endemic: N Global Rank: G5 State Rank: S4B

southwestern willow flycatcher Empidonax traillii extimus

Thickets of willow, cottonwood, mesquite, and other species along desert streams

Federal Status: LE State Status: E SGCN: N

Endemic: N Global Rank: G5T2 State Rank: S1B

DISCLAIMER

BIRDS

Sprague's pipit Anthus spragueii

The county distribution for this species includes geographic areas that the species may use during migration. Time of year should be factored into evaluations to determine potential presence of this species in a specific county. Habitat during migration and in winter consists of pastures and weedy fields (AOU 1983), including grasslands with dense herbaceous vegetation or grassy agricultural fields.

Federal Status: State Status: SGCN: Y

Endemic: N Global Rank: G3G4 State Rank: S3N

western burrowing owl Athene cunicularia hypugaea

Open grasslands, especially prairie, plains, and savanna, sometimes in open areas such as vacant lots near human habitation or airports; nests and

roosts in abandoned burrows

Federal Status: State Status: SGCN: Y
Endemic: N Global Rank: G4T4 State Rank: S2

western yellow-billed cuckoo Coccyzus americanus occidentalis

Status applies only to western population beyond the Pecos River Drainage; breeds in riparian habitat and associated drainages; springs, developed wells, and earthen ponds supporting mesic vegetation; deciduous woodlands with cottonwoods and willows; dense understory foliage is important for nest site selection; nests in willow, mesquite, cottonwood, and hackberry; forages in similar riparian woodlands; breeding season mid-May-late Sept.

Federal Status: LT State Status: SGCN: Y

Endemic: N Global Rank: G5T2T3 State Rank: S4S5B

white-faced ibis Plegadis chihi

The county distribution for this species includes geographic areas that the species may use during migration. Time of year should be factored into evaluations to determine potential presence of this species in a specific county. Prefers freshwater marshes, sloughs, and irrigated rice fields, but will attend brackish and saltwater habitats; currently confined to near-coastal rookeries in so-called hog-wallow prairies. Nests in marshes, in low trees, on the ground in bulrushes or reeds, or on floating mats.

Federal Status: State Status: T SGCN: Y

Endemic: N Global Rank: G5 State Rank: S4B

FISH

longnose dace Rhinichthys cataractae

Can only be found in the Big Bend portion of the Rio Grande. Occasionally taken in lakes and clear pools of rivers but prefers clear, flowing

water in gravelly riffles.

Federal Status: State Status: SGCN: Y
Endemic: N Global Rank: G5 State Rank: S2

speckled chub Macrhybopsis aestivalis

Found throughout the Rio Grande and lower Pecos River but occurs most frequently between the Rio Conchos confluence and the Pecos River.

Flowing water over coarse sand and fine gravel substrates in streams; typically found in raceways and runs.

Federal Status: State Status: T SGCN: Y

Endemic: N Global Rank: G3G4 State Rank: S1S2

DISCLAIMER

INSECTS

American bumblebee Bombus pensylvanicus

Habitat description is not available at this time.

Federal Status: State Status: SGCN: Y

Endemic: Global Rank: G3G4 State Rank: SNR

grande stripetail Isoperla jewetti

Originally described from El Paso Co., Texas from specimens collected in 1939.

Federal Status: State Status: SGCN: Y
Endemic: Global Rank: G1 State Rank: S1

Samalayuca Dune grasshopper Cibolacris samalayucae

Habitat description is not available at this time.

Federal Status: State Status: SGCN: Y

Endemic: Global Rank: G2? State Rank: S2?

MAMMALS

big brown bat Eptesicus fuscus

Any wooded areas or woodlands except south Texas. Riparian areas in west Texas.

Federal Status: State Status: SGCN: Y
Endemic: N Global Rank: G5 State Rank: S5

big free-tailed bat Nyctinomops macrotis

Habitat data sparse but records indicate that species prefers to roost in crevices and cracks in high canyon walls, but will use buildings, as well; reproduction data sparse, gives birth to single offspring late June-early July; females gather in nursery colonies; winter habits undetermined, but may hibernate in the Trans-Pecos; opportunistic insectivore

Federal Status: State Status: SGCN: Y
Endemic: N Global Rank: G5 State Rank: S3

black-tailed prairie dog Cynomys ludovicianus

Dry, flat, short grasslands with low, relatively sparse vegetation, including areas overgrazed by cattle; live in large family groups

Federal Status: State Status: SGCN: Y
Endemic: N Global Rank: G4 State Rank: S3

cave myotis bat Myotis velifer

Colonial and cave-dwelling; also roosts in rock crevices, old buildings, carports, under bridges, and even in abandoned Cliff Swallow (Hirundo pyrrhonota) nests; roosts in clusters of up to thousands of individuals; hibernates in limestone caves of Edwards Plateau and gypsum cave of Panhandle during winter; opportunistic insectivore.

Federal Status: State Status: SGCN: Y

Endemic: N Global Rank: G4G5 State Rank: S2S3

DISCLAIMER

MAMMALS

desert pocket gopher Geomys arenarius

Cottonwood-willow association along the Rio Grande in El Paso and Hudspeth counties; does not tolerate clayey or gravelly soils characteristic of the other Geomys species; common along irrigation ditches in the sandy river bottom area. Lives underground, but build large and conspicuous mounds; life history not well documented, but presumed to eat mostly vegetation, be active year round, and bear more than one litter per year.

Federal Status: State Status: SGCN: Y
Endemic: N Global Rank: G3G4 State Rank: S2

eastern red bat Lasiurus borealis

Red bats are migratory bats that are common across Texas. They are most common in the eastern and central parts of the state, due to their requirement of forests for foliage roosting. West Texas specimens are associated with forested areas (cottonwoods). Also common along the coastline. These bats are highly mobile, seasonally migratory, and practice a type of "wandering migration". Associations with specific habitat is difficult unless specific migratory stopover sites or wintering grounds are found. Likely associated with any forested area in East, Central, and North Texas but can occur statewide.

Federal Status: State Status: SGCN: Y
Endemic: N Global Rank: G3G4 State Rank: S4

hoary bat Lasiurus cinereus

Hoary bats are highly migratory, high-flying bats that have been noted throughout the state. Females are known to migrate to Mexico in the winter, males tend to remain further north and may stay in Texas year-round. Commonly associated with forests (foliage roosting species) but are found in unforested parts of the state and lowland deserts. Tend to be captured over water and large, open flyways.

Federal Status: State Status: SGCN: Y
Endemic: N Global Rank: G3G4 State Rank: S3

kit fox Vulpes macrotis

Open desert grassland; avoids rugged, rocky terrain and wooded areas.

Federal Status: State Status: SGCN: N

Endemic: N Global Rank: G4 State Rank: S1S2

long-legged myotis bat Myotis volans

Found in pine-oak woodland to grassland ecotone, higher elevations of Trans-Pecos. High, open woods and mountainous terrain; nursery colonies (which may contain several hundred individuals) form in summer in buildings, crevices, and hollow trees; apparently does not use caves as day roosts, but may use such sites at night; single offspring born June-July.

Federal Status: State Status: SGCN: Y

Endemic: N Global Rank: G4G5 State Rank: S1S2

long-tailed weasel Mustela frenata

Includes brushlands, fence rows, upland woods and bottomland hardwoods, forest edges & rocky desert scrub. Usually live close to water.

Federal Status: State Status: SGCN: Y
Endemic: N Global Rank: G5 State Rank: S5

DISCLAIMER

MAMMALS

mountain lion Puma concolor

Generalist; found in a wide range of habitats statewide. Found most frequently in rugged mountains & top; riparian zones.

Federal Status: State Status: SGCN: Y

Endemic: N Global Rank: G5 State Rank: S2S3

muskrat Ondatra zibethicus

Found in fresh or brackish marshes, lakes, ponds, swamps, and other bodies of slow-moving water. Most abundant in areas with cattail. Dens in bank burrow or conical house of vegetation in shallow vegetated water. It is primarily found in the Rio Grande near El Paso and in SE Texas in

the Houston area.

Federal Status: State Status: SGCN: Y
Endemic: N Global Rank: G5 State Rank: S5

pronghorn Antilocapra americana

Prefers hilly and plateau areas of open grassland, desert-grassland, and desert-scrub, where it frequents south-facing slopes and other sheltered

areas.

Federal Status: State Status: SGCN: Y
Endemic: N Global Rank: G5 State Rank: S3

rock mouse Peromyscus nasutus

Rocky areas and talus slopes above 6000 feet. General vegetation associations include madrone, oak, maple, juniper, pinyon and ponderosa pine.

Federal Status: State Status: SGCN: Y
Endemic: N Global Rank: G5 State Rank: S4

Townsend's big-eared bat Corynorhinus townsendii

In Texas, habitat ranges from desert scrub to pinyon-juniper woodland, consistently in areas with canyons or cliffs (Schmidly 1991). Roosts in

caves, crevases, trees, and buildings in the Panhandle and Trans-Pecos.

Federal Status: State Status: SGCN: Y

Endemic: N Global Rank: G4 State Rank: S3?

western hog-nosed skunk Conepatus leuconotus

Habitats include woodlands, grasslands & deserts, to 7200 feet, most common in rugged, rocky canyon country; little is known about the habitat

of the ssp. telmalestes

Federal Status: State Status: SGCN: Y
Endemic: N Global Rank: G4 State Rank: S4

DISCLAIMER

MAMMALS

western small-footed myotis bat Myotis ciliolabrum

Mountainous regions of the Trans-Pecos, usually in wooded areas, also found in grassland and desert scrub habitats; roosts beneath slabs of rock, behind loose tree bark, and in buildings; maternity colonies often small and located in abandoned houses, barns, and other similar structures; apparently occurs in Texas only during spring and summer months; insectivorous

Federal Status: State Status: SGCN: Y
Endemic: N Global Rank: G5 State Rank: S3

western spotted skunk Spilogale gracilis

Brushy canyons, rocky outcrops (rimrock) on hillsides and walls of canyons. In semi-arid brushlands in U.S., in wet tropical forests in Mexico.

When inactive or bearing young, occupies den in rocks, burrow, hollow log, brush pile, or under building.

Federal Status: State Status: SGCN: Y
Endemic: N Global Rank: G5 State Rank: S5

western yellow bat Lasiurus xanthinus

Forages over water both perennial and intermittent sources, found at low elevations (< 6,000 feet), roosts in vegetation (yucca, hackberry, sycamore, cypress, and especially palm); also hibernates in palm; locally common in residential areas landscaped with palms in Tuscon and

Phoenix, Arizona; young born in June; insectivore

Federal Status: State Status: SGCN: Y
Endemic: N Global Rank: G4G5 State Rank: S1

MOLLUSKS

Franklin Mountain talus snail Sonorella metcalfi

Terrestrial; bare rock, talus, scree; inhabits igneous talus most commonly of rhyolitic origin

Federal Status: State Status: SGCN: Y
Endemic: N Global Rank: G2 State Rank: S2

Franklin Mountain wood snail Ashmunella pasonis

Terrestrial; bare rock, talus, scree; talus slopes, usually of limestone, but also of rhyolite, sandstone, and siltstone, in arid mountain ranges

Federal Status: State Status: SGCN: Y
Endemic: Global Rank: G2G3 State Rank: S2

Huecos Mountains talus snail Sonorella huecoensis

Habitat description is not available at this time.

Federal Status: State Status: SGCN: Y
Endemic: Y Global Rank: G1G2 State Rank: S1

REPTILES

Big Bend slider Trachemys gaigeae

Aquatic: Rivers with permanent water; ponds, impoundments, and stock tanks along the Rio Grande; basks on shore, emergent rocks, logs, vegetation mats, or at water surface.

DISCLAIMER

REPTILES

Federal Status: State Status: SGCN: Y
Endemic: N Global Rank: G3 State Rank: S2

Chihuahuan Desert lyre snake Trimorphodon vilkinsonii

Terrestrial: Rocky areas with plenty of crevices and fissures. Preferred habitats include rock piles, outcrops and talus slopes. Also occurs in

desert flats, succulent and scrub, and mountain canyons to about 6000 feet.

Federal Status: State Status: SGCN: Y
Endemic: N Global Rank: G4 State Rank: S4

gray-checkered whiptail Aspidoscelis dixoni

Terrestrial: The habitat comprises rocky plains, dry washes, canyon bottoms, and desert scrub (ocotillo, creosotebush, opuntia) (Bartlett and Bartlett 1999); generally on rocky soils of desert shrublands and degraded grasslands on alluvial benches, canyon bottoms, and lower

southwestern mountain slopes (Scudday 1973, Degenhardt et al. 1996).

Federal Status: State Status: SGCN: Y
Endemic: N Global Rank: G5 State Rank: S2

longnose leopard lizard Gambelia wislizenii

This species occurs in open gravelly or sandy habitats that are sparsely vegetated with scattered brush. When threatened, this lizard will retreat to

brush piles and rodent burrows to escape.

Federal Status: State Status: SGCN: Y
Endemic: N Global Rank: G5 State Rank: S4

Mexican hog-nosed snake Heterodon kennerlyi

Habitat description is not available at this time.

Federal Status: State Status: SGCN: N

Endemic: Global Rank: G4 State Rank: SNR

mountain short-horned lizard Phrynosoma hernandesi

Terrestrial: Generally restricted to high elevation grasslands and forested areas with open ground; soil may vary from rocky to sandy; burrows

into soil or occupies rodent burrow when inactive.

Federal Status: State Status: T SGCN: Y
Endemic: N Global Rank: G5 State Rank: S2

roundtail horned lizard Phrynosoma modestum

This species seems to prefer rocky or gravelly substrates in open areas that are sparsely vegetated.

Federal Status: State Status: SGCN: Y
Endemic: N Global Rank: G5 State Rank: S4

Texas horned lizard Phrynosoma cornutum

DISCLAIMER

REPTILES

Terrestrial: Open habitats with sparse vegetation, including grass, prairie, cactus, scattered brush or scrubby trees; soil may vary in texture from sandy to rocky; burrows into soil, enters rodent burrows, or hides under rock when inactive. Occurs to 6000 feet, but largely limited below the pinyon-juniper zone on mountains in the Big Bend area.

Federal Status: State Status: T SGCN: Y
Endemic: N Global Rank: G4G5 State Rank: S3

western box turtle Terrapene ornata

Terrestrial: Ornate or western box trutles inhabit prairie grassland, pasture, fields, sandhills, and open woodland. They are essentially terrestrial but sometimes enter slow, shallow streams and creek pools. For shelter, they burrow into soil (e.g., under plants such as yucca) (Converse et al. 2002) or enter burrows made by other species.

Federal Status: State Status: SGCN: Y
Endemic: N Global Rank: G5 State Rank: S3

western hognose snake Heterodon nasicus

Terrestrial: Shortgrass or mixed grass prairie, with gravel or sandy soils. Often found associated with draws, floodplains, and more mesic

habitats within the arid landscape. Frequently occurs in shrub encroached grasslands.

Federal Status: State Status: SGCN: Y
Endemic: N Global Rank: G5 State Rank: S4

western massasauga Sistrurus tergeminus

Terrestrial: Shortgrass or mixed grass prairie, with gravel or sandy soils. Often found associated with draws, floodplains, and more mesic

habitats within the arid landscape. Frequently occurs in shrub encroached grasslands.

Federal Status: State Status: SGCN: Y
Endemic: N Global Rank: G3G4 State Rank: S3

western rattlesnake Crotalus viridis

Terrestrial: Dry desert and prairie grasslands, shrub desert rocky hillsides; edges of arid and semi-arid river breaks.

Federal Status: State Status: SGCN: Y
Endemic: N Global Rank: G5 State Rank: S5

PLANTS

Alamo beardtongue Penstemon alamosensis

Rocky soils derived from limestone (in Texas), usually in sheltered sites, often on north facing slopes and in mesic canyon bottoms, occasionally

in rock crevices or among unbrowsed shrubs; flowering late April-June

Federal Status: State Status: SGCN: Y
Endemic: N Global Rank: G3 State Rank: S1

DISCLAIMER

PLANTS

Bigelow's desert grass Blepharidachne bigelovii

Restricted to xeric limestone or various gypsum-influenced habitats; Perennial; Flowering March-Dec; Fruiting March-Dec

Federal Status: State Status: SGCN: Y Endemic: N Global Rank: G3 State Rank: S3

Comal snakewood Colubrina stricta

In El Paso County, found in a patch of thorny shrubs in colluvial deposits and sandy soils at the base of an igneous rock outcrop; the historic Comal County record does not describe the habitat; in Mexico ,found in shrublands on calcareous, gravelly, clay soils with woody associates; flowering late spring or early summer

Federal Status: State Status: SGCN: Y Endemic: N Global Rank: G2 State Rank: S1

Escobaria dasyacantha var. dasyacantha dense cory cactus

Lechuguilla-sotol or creosote bush shrublands, grasslands, and oak-juniper woodlands on gravelly, rocky, and/or loamy soils over igneous or limestone substrates at moderate elevations 750-1800 m (2450-5900 ft) in the Chihuahuan Desert; flowering March-May (-July), fruiting (May-)

June-August

Federal Status: State Status: SGCN: Y Endemic: N Global Rank: G3T3 State Rank: S3

desert night-blooming cereus Peniocereus greggii var. greggii

Chihuahuan Desert shrublands or shrub invaded grasslands in alluvial or gravelly soils at lower elevations, 1200-1500 m (3900-4900 ft), on slopes, benches, arroyos, flats, and washes; flowering synchronized over a few nights in early May to late June when almost all mature plants bloom, flowers last only one day and open just after dark, may flower as early as April

SGCN: Y Federal Status: State Status: Global Rank: G3G4T3 Endemic: N State Rank: S2

fleshy tidestromia Tidestromia carnosa

Occurs in saline or gypseous soils in open situations; Annual; Flowering March-Nov; Fruiting April-Nov Federal Status: State Status: SGCN: Y Global Rank: G3 Endemic: N State Rank: S2

Salvia summa great sage

Limestone cliffs and slopes in the Guadalupe and Franklin Mountains; Perennial; Flowering April-June; Fruiting May-Oct

Federal Status: State Status: SGCN: Y Endemic: N Global Rank: G3 State Rank: S2

Hueco rock-daisy Perityle huecoensis

North-facing or otherwise mostly shaded limestone cliff faces within relatively mesic canyon system; flowering spring-fall

SGCN: Y Federal Status: State Status: State Rank: S1 Endemic: N Global Rank: G1

DISCLAIMER

PLANTS

lyreleaf twistflower Streptanthus carinatus ssp. carinatus

Occurs on igneous and limestone slopes and alluvial fans (Carr 2015).

Federal Status: State Status: SGCN: Y
Endemic: N Global Rank: G4T3T4 State Rank: S3

Mt. Davis brickellbush Brickellia parvula

Occurs on rocky slopes and ridges in the mountains of the southwestern U.S. at elevations between 1200 and 2100 m; Perennial; Flowering Aug-

Sept; Fruiting Sept-Oct

Federal Status: State Status: SGCN: Y
Endemic: N Global Rank: G3 State Rank: S1

Payson's hiddenflower Cryptantha paysonii

Rocky limestone slopes in mountains; Perennial; Flowering May; Fruiting May-June

Federal Status: State Status: SGCN: Y
Endemic: N Global Rank: G3 State Rank: S1

Plank's catchfly Silene plankii

Franklin Mountains of El Paso County, occurring in crevices on shaded igneous cliff faces above ca. 5000 ft.; Perennial; Flowering summer-

early autumn

Federal Status: State Status: SGCN: Y
Endemic: N Global Rank: G2 State Rank: S1

resin-leaf brickellbush Brickellia baccharidea

Mixed desert shrublands on bajada slopes and in arroyos on sandy or gravelly soils derived from limestone, but also known from igneous

substrates; flowering September-April

Federal Status: State Status: SGCN: Y
Endemic: N Global Rank: G3 State Rank: S1

Ripley's senna Senna ripleyana

Gravelly hilltops in arid grasslands and creosote flats in Chihuahuan Desert; elevation ranges 1,200-1,500 m (3,900-4,900 ft); flowering/fruiting

July-October

Federal Status: State Status: SGCN: Y
Endemic: N Global Rank: G1 State Rank: SH

sand prickly-pear Opuntia arenaria

Deep, loose or semi-stabilized sands in sparsely vegetated dune or sandhill areas, or sandy floodplains in arroyos; flowering May-June

Federal Status: State Status: SGCN: Y
Endemic: N Global Rank: G2 State Rank: S2

DISCLAIMER

PLANTS

Scheer's cory cactusCoryphantha scheeri var. uncinata

Rocky hillsides (Carr 2015).

Federal Status: State Status: SGCN: Y
Endemic: N Global Rank: G4TUO State Rank: S2

smooth bur-cucumber Sicyos glaber

Mesic canyons in the Chisos and Guadalupe Mountains (Carr 2015).

Federal Status: State Status: SGCN: Y
Endemic: N Global Rank: G3 State Rank: S1

Sneed's pincushion cactus Escobaria sneedii var. sneedii

Xeric limestone outcrops on rocky, usually steep slopes in desert mountains, in the Chihuahuan Desert succulent shrublands or grasslands;

flowering April-September (peak usually in April, sometimes opportunistically after summer rains; fruiting August - November

Federal Status: LE State Status: E SGCN: Y

Endemic: N Global Rank: G2G3QT2Q State Rank: S2

stalked rhombopod Cleomella longipes

Locally common in sparingly vegetated sandy or alkaline soils and along margins of seasonal wetlands in the Trans-Pecos (Carr 2015).

Federal Status: State Status: SGCN: Y

Endemic: N Global Rank: G3G4 State Rank: S3

Texas false saltgrass Allolepis texana

Sandy to silty soils of valley bottoms and river floodplains, not generally on alkaline or saline sites; Perennial; Flowering (May-) July-October

depending on rainfall

Federal Status: State Status: SGCN: Y
Endemic: N Global Rank: G2 State Rank: S1

Vasey's bitterweed Hymenoxys vaseyi

Occurs on xeric limestone cliffs and slopes at mid- to high elevations in desert shrublands.

Federal Status: State Status: SGCN: Y
Endemic: N Global Rank: G2 State Rank: S1

Waterfall's milkvetch Astragalus waterfallii

Rocky limestone slopes; Perennial; Flowering Feb-May; Fruiting April- May

Federal Status: State Status: SGCN: Y
Endemic: N Global Rank: G3? State Rank: S3

DISCLAIMER

PLANTS

Wheeler's spurge Euphorbia geyeri var. wheeleriana

Sparingly vegetated, loose eolian quartz sand on reddish sand dunes or coppice mounds; flowering and fruiting at least August-September,


probably earlier and later, as well

Federal Status: State Status: SGCN: Y
Endemic: N Global Rank: G5T2 State Rank: S1

Wright's fishhook cactus Mammillaria wrightii var. wrightii

Franklin Mountains (Carr 2015)

Federal Status: State Status: SGCN: Y
Endemic: N Global Rank: G4T3 State Rank: SH

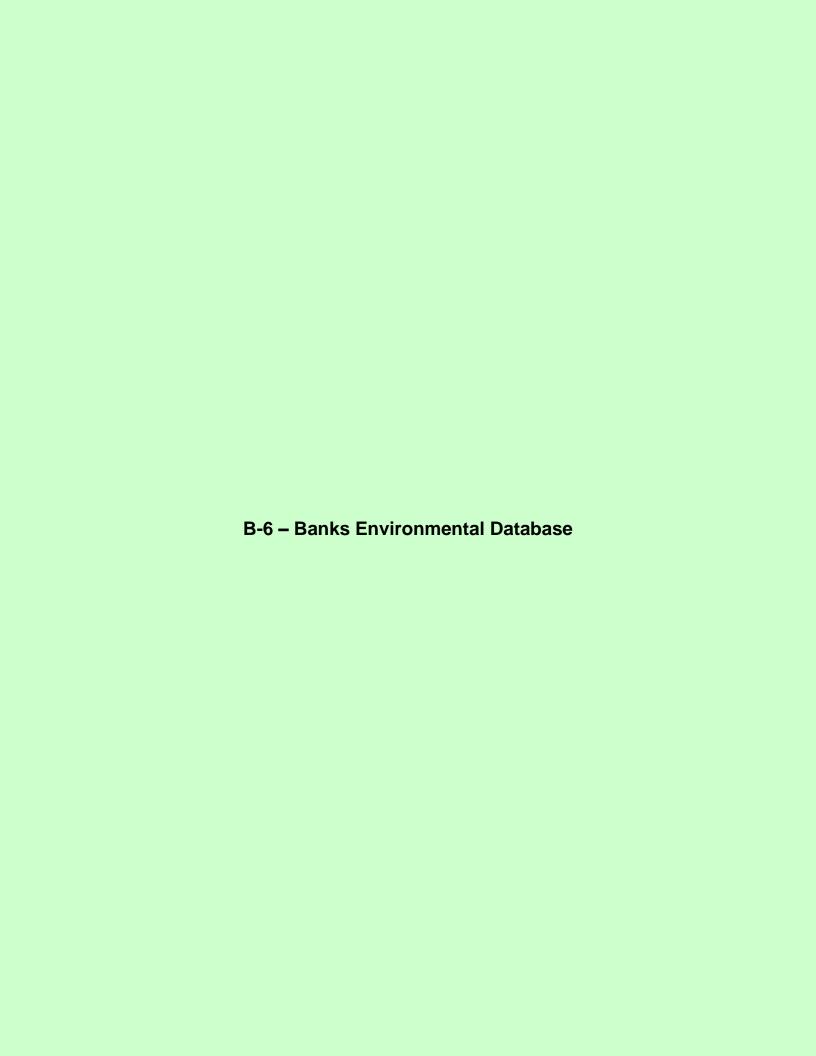

Prepared for: ESSCO ENVIRONMENTAL, INC. 1000 Newman St. El Paso, TX 79902



Regulatory ASTM E1527-21/AAI Compliant EPW-23-13_Clardy Fox EI Paso, TX EI Paso County ES 142526

ES-143536

Tuesday, February 13, 2024

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Geographic Summary



Location

El Paso County, TX

Target location is 1.84 acres, 0.003 square miles, and has a 0.25 mile perimeter

| Coordinates (| (centroid) | |
|---------------|------------|--|
| | | |

Lat/Long in Degrees Minutes Seconds 31° 45' 16.43", -106° 25' 45.98"

Lat/Long in Decimal Degrees 31.754562509509952, -106.4294393034645

X/Y in NAD83 / UTM Zone 13N 364616.833535883, 3514120.63830068

Elevation (centroid)

3695.44 ft

| Zip Codes Searched | |
|----------------------|-----------|
| Search Distance (mi) | Zip Codes |
| Subject Property | 79905 |
| 0.25 miles | 79905 |
| 0.5 miles | 79905 |
| 1.0 miles | 79905 |

| Topos Searched | |
|------------------|----------------------------------|
| Search Distance | Topo Name |
| Subject Property | El Paso (1973) |
| 0.25 miles | El Paso (1973) |
| 0.5 miles | Ysleta NW (1967), El Paso (1973) |
| 1.0 miles | Ysleta NW (1967), El Paso (1973) |

Dataset Summary




| Datasets Searched | | Distance | Mapped | Unmapped | Total |
|--|---|----------|--------|----------|-------|
| Federal - ASTM 1527-21/AAI Required | | | | | |
| CERCLIS - National Priority List (CER NPL) | • | 1.0 | 0 | 0 | 0 |
| CERCLIS - Delisted National Priority List (CER DNPL) | | 0.5 | 0 | 0 | 0 |
| CERCLIS (CER) | • | 0.5 | 0 | 0 | 0 |
| CERCLIS - No Further Remedial Action Planned (CER NFRAP) | | 0.5 | 0 | 0 | 0 |
| RCRA - Corrective Actions (RCRA COR) | • | 1.0 | 0 | 0 | 0 |
| RCRA - Treatment, Storage, Disposal (RCRA TSD) | | 0.5 | 0 | 0 | 0 |
| RCRA - Very Small Quantity Generators (RCRA VSG) | • | 0.25 | 0 | 0 | 0 |
| RCRA - Small Quantity Generators (RCRA SQG) | • | 0.25 | 0 | 0 | 0 |
| RCRA - Large Quantity Generators (RCRA LQG) | • | 0.25 | 0 | 0 | 0 |
| Federal Brownfield (FED BF) | | 0.5 | 0 | 0 | 0 |
| Federal Institutional Control (FED IC) | • | 0.5 | 0 | 0 | 0 |
| Federal Engineering Control (FED EC) | • | 0.5 | 0 | 0 | 0 |
| Emergency Response Notification System (ERNS) | • | 0.25 | 0 | 1 | 1 |
| RCRA (RCRA) | • | 0.25 | 1 | 0 | 1 |
| Tribal - ASTM 1527-21/AAI Required | | | | | |
| Tribal Region 6 - Leaking Petroleum Storage Tank (LPST) | • | 0.5 | 0 | 0 | 0 |
| Tribal Region 6 - Petroleum Storage Tank (PST) | • | 0.25 | 0 | 0 | 0 |
| State - ASTM 1527-21/AAI Required | | | | | |
| State National Priority List (ST PL) | • | 1.0 | 0 | 0 | 0 |
| State CERCLIS (ST CER) | | 0.5 | 0 | 0 | 0 |
| Solid Waste (SW) | • | 0.5 | 0 | 0 | 0 |

Dataset Summary




| Leaking Petroleum Storage Tank (LPST) | | 0.5 | 0 | 0 | 0 | |
|---------------------------------------|---|------|---|---|---|--|
| Petroleum Storage Tank (PST) | • | 0.25 | 0 | 0 | 0 | |
| State Institutional Control (IC) | • | 0.25 | 0 | 0 | 0 | |
| State Engineering Control (EC) | • | 0.5 | 0 | 0 | 0 | |
| Voluntary Cleanup Program (VCP) | | 0.5 | 0 | 0 | 0 | |
| State Brownfield (BF) | • | 0.5 | 0 | 0 | 0 | |
| Hazardous Waste (HW) | • | 0.5 | 1 | 0 | 1 | |
| Dry Cleaner (DRYC) | • | 0.25 | 0 | 0 | 0 | |
| Municipal Setting Designation (MSD) | • | 0.25 | 0 | 0 | 0 | |
| Local - Non-ASTM 1527-21/AAI Required | | | | | | |
| Leaking Petroleum Storage Tank (LPST) | • | 0.5 | 0 | 0 | 0 | |
| Petroleum Storage Tank (PST) | • | 0.25 | 0 | 0 | 0 | |
| Total Sites Found | | | 2 | 1 | 3 | |

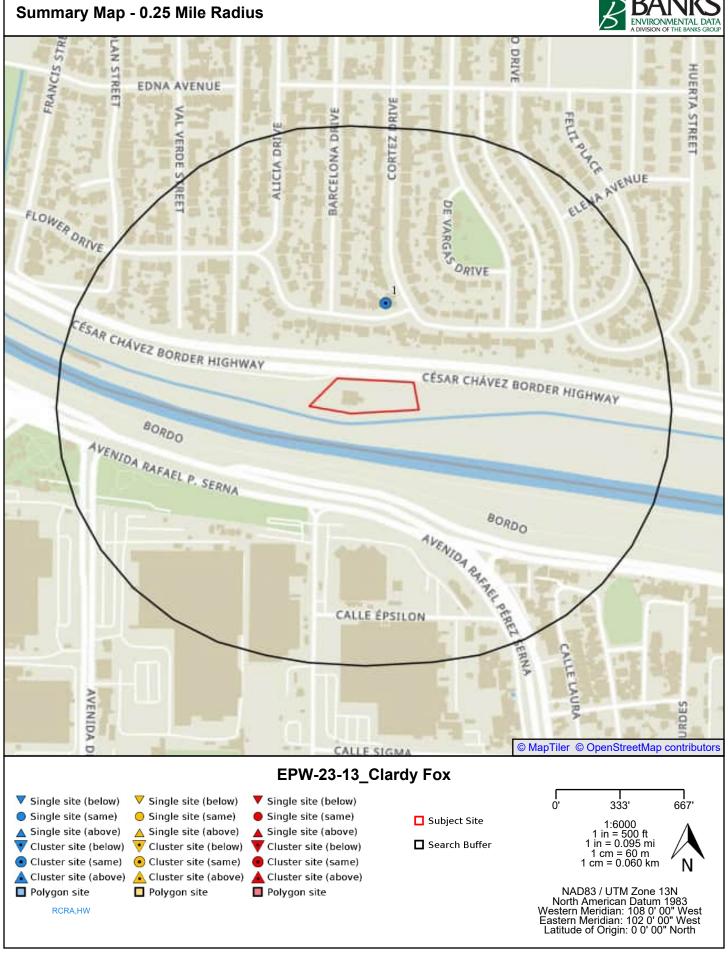

Summary Map - 0.5 Mile Radius



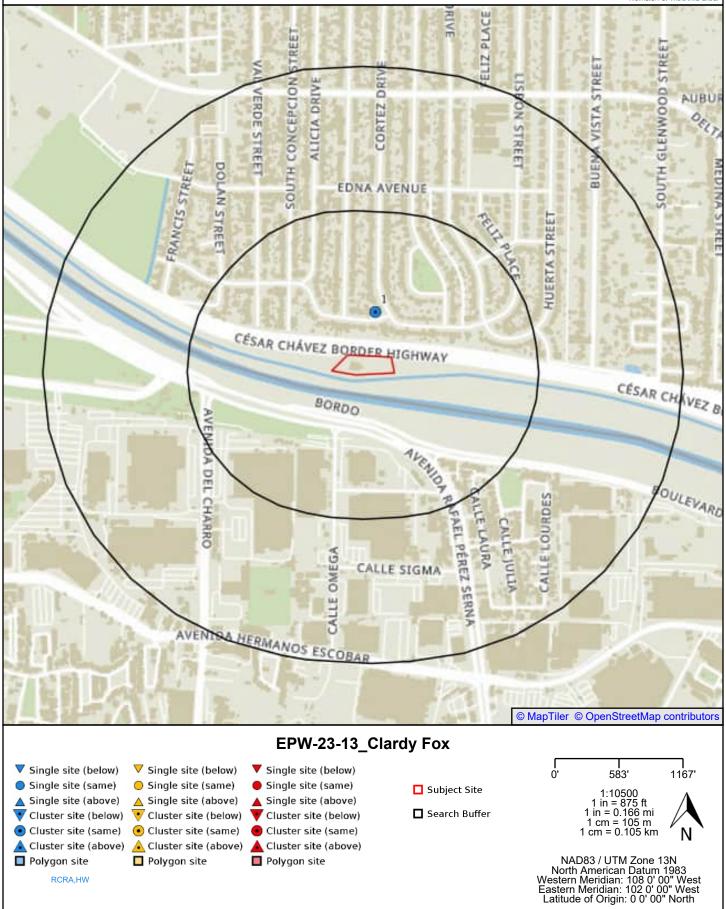

Summary Map - 1.0 Mile Radius MAKEDA PAISAND DRIVE ALAMEDA AVENUE HLANCO AVENUE GRIGER AVENU AUBURN AVENUE ATHENS COURS SAMME TO NECHES AVENUE KURITA AVENUE CESAR CH VEZ BORDER HIGH CALLE STOMA BY DUNANT © MapTiler © OpenStreetMap contributors EPW-23-13_Clardy Fox ▼ Single site (below) ▼ Single site (below) ▼ Single site (below) 2000' 1000' Single site (same) Single site (same) Single site (same) Subject Site 1:18000 △ Single site (above) 1 in = 15000 ft 1 in = 1500 ft 1 in = 0.284 mi 1 cm = 180 m 1 cm = 0.180 km Single site (above) ▲ Single site (above) Cluster site (below) ■ Search Buffer Cluster site (below) Cluster site (below)

Cluster site (same)

Cluster site (above)

Polygon site

Cluster site (same)

RCRA,HW


Polygon site

Cluster site (same)

Polygon site

▲ Cluster site (above) ▲ Cluster site (above)

NAD83 / UTM Zone 13N North American Datum 1983 Western Meridian: 108 0' 00" West Eastern Meridian: 102 0' 00" West Latitude of Origin: 0 0' 00" North

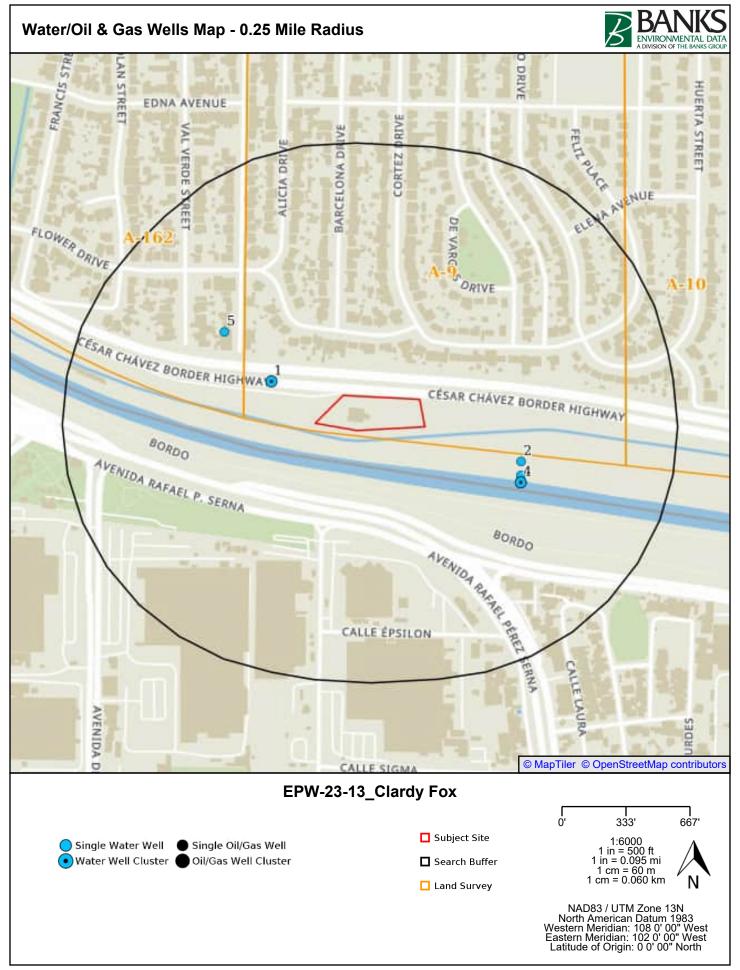

Water/Oil & Gas Wells Summary




| Map ID | Well ID | Owner | Well Type | Elevation |
|--------|---------------------|--|------------|------------|
| 1 | 4913812 | International Boundary and Water Commission | Water Well | 3698.59 ft |
| 1 | 4913808 | El Paso Water Utility/ Public Service Board | Water Well | 3698.59 ft |
| 2 | 4913844 | U. S. Bureau of Reclamation | Water Well | 3693.31 ft |
| 3 | USGS314513106253502 | USGS | Water Well | 3692.75 ft |
| 4 | 4913842 | U. S. Bureau of Reclamation | Water Well | 3685.70 ft |
| 4 | 4913841 | U.S. Bureau of Reclamation | Water Well | 3685.70 ft |
| 4 | 4913843 | U. S. Bureau of Reclamation | Water Well | 3685.70 ft |
| 5 | USGS314518106255001 | USGS | Water Well | 3697.05 ft |

Source

U.S. Geological Survey, Texas Water Development Board (GW and Submitted Driller's Report), Texas Commission of Environmental Quality (PWS), Railroad Commission of Texas (Production Data)

Disclaimer

This well scan from Banks Environmental Data, Inc. has included a digital search of state and federal wells currently digitized in our geospatial database. Since this scan includes only well data that is currently mapped in our geospatial database, more wells could exist within the search area. For a complete well search or to locate more details, please contact Banks to obtain a full Water Well Report or Oil & Gas Well/Pipeline Search Report. More detailed individual well records can also be obtained from Banks for an additional cost, please reference a Well ID # from this well scan. All well locations are based on information obtained from state and federal sources. Although Banks performs quality assurance and quality control on all data, inaccuracies of the records and mapped locations could possibly be traced to the specific regulatory authority or individual well driller. Banks Environmental Data, Inc. cannot fully guarantee the accuracy of the data or well location(s) of the maps and records maintained by the state and federal agencies.

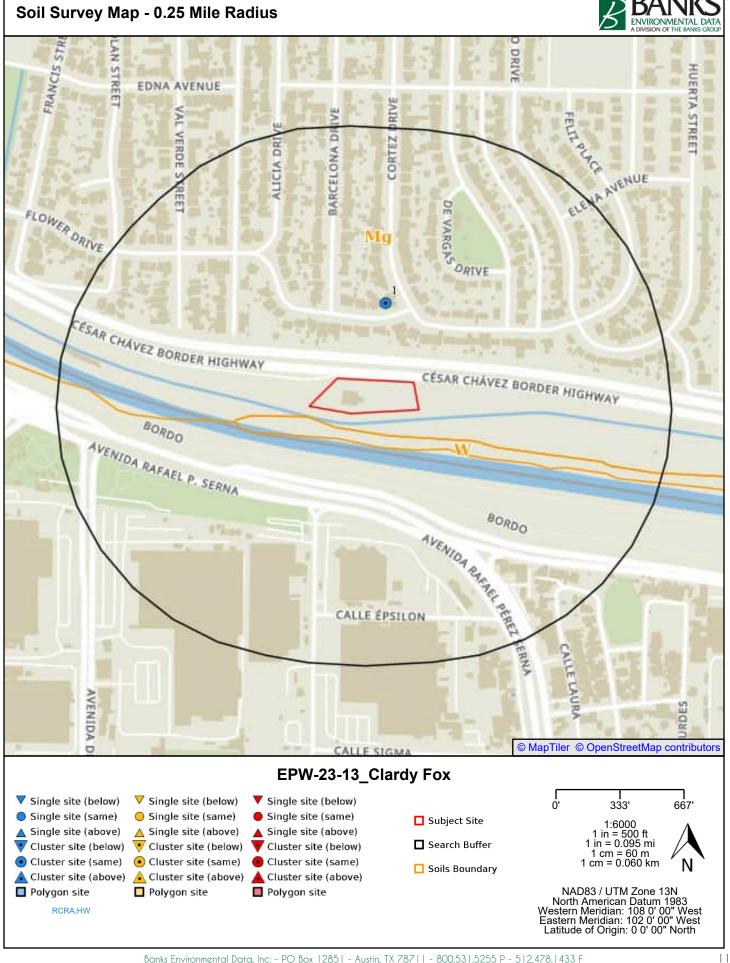

Soils Details



Soil Types Found

Subject Property

Mg

Within 0.25 miles of Subject Property

W

Soil Type Descriptions

Mg - Made land, gila soil material

Percent Hydric 5

Minimum Depth to Bedrock

Gila (90%)

Hydrologic Group Moderately low runoff potential

Soil Drainage Class Well drained

Corrosion Potential - Uncoated Steel Moderate

Depth to Restrictive Feature

| Horizon | Soil Texture | Upper Boundary | Lower Boundary | AASHTO | Unified |
|---------|---------------------|----------------|----------------|--------|---------|
| H1 | Fine sandy loam | 0 cm | 25 cm | A-4 | ML |
| H2 | Loam, silt loam | 25 cm | 56 cm | A-4 | ML, SM |
| H3 | Gravelly sandy loam | 56 cm | 69 cm | A-4 | ML, SM |
| H4 | Silt loam | 69 cm | 160 cm | A-4 | ML, SM |

Unnamed, hydric (5%)

Hydrologic Group

Soil Drainage Class

Corrosion Potential - Uncoated Steel

Depth to Restrictive Feature

Unnamed (5%)

Hydrologic Group

Soil Drainage Class

Corrosion Potential - Uncoated Steel

Depth to Restrictive Feature

W - Water

Percent Hydric 0

Minimum Depth to Bedrock

Water (100%)

Hydrologic Group High runoff potential

Soil Drainage Class

Corrosion Potential - Uncoated Steel

Depth to Restrictive Feature

Soils Descriptions



| AASHTO Classification Definitions | |
|-----------------------------------|--|
| A-1, A-1-a, A-1-b | Granular materials (35% or less passing No. 200 sieve), sonte fragments, gravel and sand |
| A-2, A-2-4, A-2-5, A-2-6, A-2-7 | Granular materials (35% or less passing No. 200 sieve), silty or clayey gravel and sand |
| A-3 | Granular materials (35% or less passing No. 200 sieve), fine sand |
| A-4 | Silt-Clay materials (more than 35% passing No. 200 sieve), silty soils |
| A-5 | Silt-Clay materials (more than 35% passing No. 200 sieve), silty soils |
| A-6 | Silt-Clay materials (more than 35% passing No. 200 sieve), clayey soils |
| A-7, A-7-5, A-7-6 | Silt-Clay materials (more than 35% passing No. 200 sieve), clayey soils |
| A-8 | Silt-Clay materials (more than 35% passing No. 200 sieve), clayey soils |

| Unified Classification Definitions | |
|---|---|
| сн | Fine-grained soils, silts and clays (liquid limit is 50% or more), Fat Clay |
| CL, CL-A (proposed), CL-K (proposed), CL-ML, CL-O (proposed), CL-T (proposed) | Fine-grained soils, silts and clays (liquid limit is less than 50%), Lean Clay |
| GC, GC-GM | Coarse-grained soils, Gravels, gravel with fines, Clayey Gravel |
| GM | Coarse-grained soils, Gravels, gravel with fines, Silty Gravel |
| GP, GP-GC, GP-GM | Coarse-grained soils, Gravels, clean gravels, Poorly Graded Gravel |
| GW, GW-GC, GW-GM | Coarse-grained soils, Gravels, clean gravels, Well-Graded Gravel |
| MH, MH-A, MH-K, MH-O, MH-T | Fine-grained soils, silts and clays (liquid limit is 50% or more), Elastic Silt |
| ML, ML-A (proposed), ML-K (proposed), ML-O (proposed), ML-T (proposed) | Fine-grained soils, silts and clays (liquid limit is less than 50%), Silt |
| OH, OH-T (proposed) | Fine-grained soils, silts and clays (liquid limit is 50% or more), Organic Clay or Organic Silt |
| OL | Fine-grained soils, silts and clays (liquid limit is less than 50%), Organic Clay or Organic Silt |
| PT | Highly organic soils, Peat |
| SC, SC-SM | Coarse-grained soils, Sands, sands with fines, Clayey Sand |
| SM | Coarse-grained soils, Sands, sands with fines, Silty Sand |
| SP, SP-SC, SP-SM | Coarse-grained soils, Sands, clean sands, Poorly Graded Sand |
| SW, SW-SC, SW-SM | Coarse-grained soils, Sands, clean sands, Well-Graded Sand |

Source


Natural Resources Conservation Service, Soil Survey Geographic (SSURGO) Database.

Disclaimer

This Soils Survey from Banks Environmental Data, Inc. has searched Natural Resources Conservation Service (NRCS) and the Soil Survey Geographic Database (SSURGO). All soil data presented on the map and in the details section are based on information obtained from NRCS. Although Banks performs quality assurance and quality control on all data, inaccuracies of the data and mapped locations could possibly be traced to the source. Banks Environmental Data, Inc. cannot fully guarantee the accuracy of the SSURGO database maintained by NRCS.


Current Imagery Overlay Map - 0.5 Mile Radius



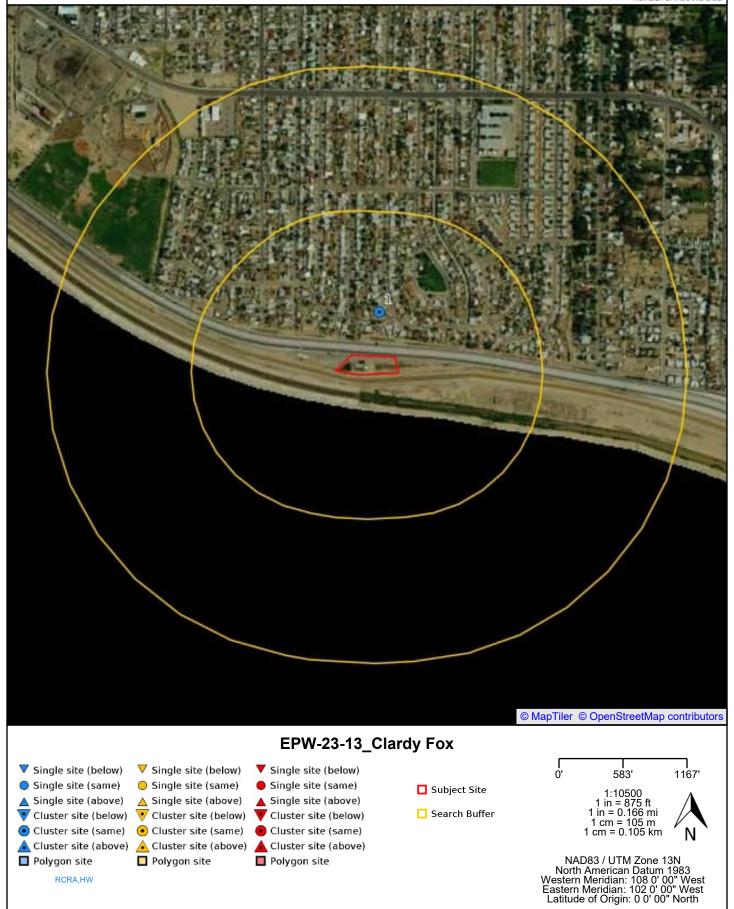


Topographic Overlay Map - 1.0 Mile Radius



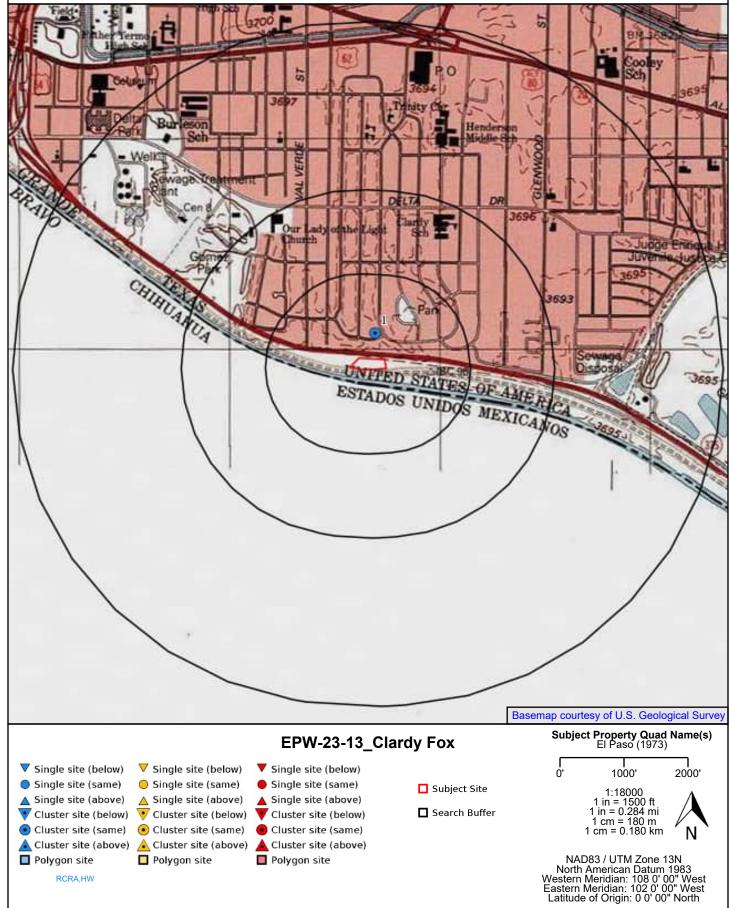

Zip Code Map - 1.0 Mile Radius CHMEDA PAISAND DRIVE ALAMEDA AVENUE HLANCO AVENUE GRIGER AVENU AUBURN AVENUE ATHENS COURS SARINE TO NECHES AVENUE KURTTA AVENUE CESAR CH VEZ BORDES HIGHWAY CALLE STOMA BY DUNANT © MapTiler © OpenStreetMap contributors EPW-23-13_Clardy Fox ▼ Single site (below) ▼ Single site (below) ▼ Single site (below) 2000' 1000' Single site (same) Single site (same) Single site (same) Subject Site 1:18000 △ Single site (above) Single site (above) ▲ Single site (above)

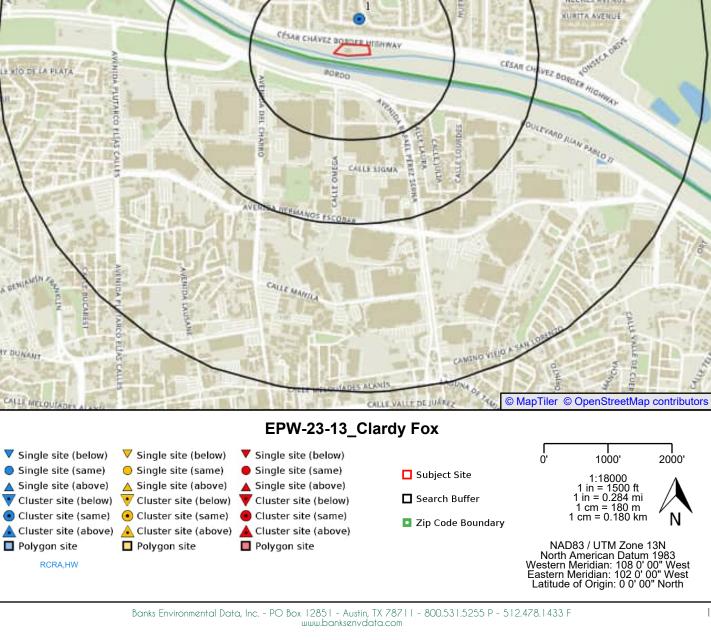

Mapped Sites Summary



| Dataset | Distance | Elevation | Map ID | Facility Site Name | Facility Site Address | Details Page # |
|---------|----------|-----------|--------|--|-------------------------------|-------------------|
| HW | 0.08mi N | -1.21 ft | 1 | CALLE REO YEAPACHIC JUAREZ | 5213 FLOWER DR, EL PASO 79905 | 19 |
| RCRA | 0.08mi N | -1.21 ft | 1 | TRANSPORTES UNION - CALLE REO YEAPACHIC JUAREZ | 5213 FLOWER DR, EL PASO 79905 | 20 |

^{*}Sites are sorted by database tier, dataset, and distance from the subject property.

End of Mapped Sites Summary

Unmapped Sites Summary



| Dataset | Facility Site Name | Facility Site Address | Details Page # |
|---------|--------------------|-----------------------|-------------------|
| ERNS | | TX-375 | 23 |

End of Unmapped Sites Summary

Map ID 1: HW - 5213 FLOWER DR



HW - Hazardous Waste

| Map ID: 1 | | Source: TCEQ |
|--------------------------------|--------------------------|----------------------------------|
| Register #: 41695 | HW - Hazardous Waste | Banks ID: 41695 |
| CALLE REO YEAPACHIC JUAREZ | | Rel. Loc.: 0.08mi N |
| 5213 FLOWER DR, EL PASO, 79905 | | Elevation: 3694.23 ft (-1.21 ft) |
| Location Description: | 5213 Flower, El Paso, TX | |
| Tceq Permit: | | |
| Facility Type: | Transporter | |
| Status: | INACTIVE | |
| Company Name: | TRANSPORTES UNION | |
| Contact Name: | MARIO OLVERA | |
| Contact Phone: | 915-5439734 | |
| Tceq Facility Id: | 18080 | |
| Last Ammend: | 2011-10-03 | |
| Last Nor Update: | 2011-10-17 | |
| Notification Date: | 1990-09-14 | |

Sites in Map ID 1 Cluster

| Dataset | Facility Site Name | Facility Site Address | Page # |
|---------|---|-------------------------------|--------|
| HW | CALLE REO YEAPACHIC JUAREZ | 5213 FLOWER DR, EL PASO 79905 | 19 |
| RCRA | TRANSPORTES UNION - CALLE REO YEAPACHIC JUAREZ | 5213 FLOWER DR, EL PASO 79905 | 20 |

End of HW Section



RCRA - RCRA

| Map ID: 1 | | Source: EPA |
|---------------------------------|---|----------------------------------|
| EPA Handler ID: TXR000079277 | RCRA - RCRA | Banks ID: TXR000079277 |
| TRANSPORTES UNION - CALLE RE | O YEAPACHIC JUAREZ | Rel. Loc.: 0.08mi N |
| 5213 FLOWER DR, EL PASO, 79905 | | Elevation: 3694.23 ft (-1.21 ft) |
| Active Site Indicator: | Inactive | |
| Activity Location: | TX | |
| Non Notifier: | Not a non-notifier | |
| Receive Date: | 2011-10-17 | |
| Accessibility: | Not provided | |
| Region: | 06 | |
| State: | TX | |
| Generator Status Universe: | N | |
| Mailing Address: | 5213 FLOWER DR | |
| Mailing City: | EL PASO | |
| Mailing State: | TX | |
| Mailing Zip Code: | 79905 | |
| Contact Name: | MARIO OLVERA | |
| Contact Address: | 5213 FLOWER DR | |
| Contact City: | EL PASO | |
| Contact State: | TX | |
| Contact Zip: | 79905 | |
| Contact Title: | ENVIRONMENTAL MANAGER | |
| Owner Name: | TRANSPORTES UNION | |
| Operator Name: | TRANSPORTES UNION - CALLE REO YEAPACHIC | |
| Operator Type: | Private | |
| Operator Seq Num: | 2 | |
| Naics Description: | GENERAL FREIGHT TRUCKING, LOCAL | |
| Importer Activity: | N | |
| Transporter Activity: | N | |
| Transfer Facility: | N | |
| Recycler Activity: | N | |
| Onsite Burner Exemption: | N | |
| Furnace Exemption: | N | |
| Underground Injection Activity: | N | |
| Receives Waste From Offsite: | N | |
| Universal Waste: | N | |
| Universal Waste Dest Facility: | N | |
| Used Oil Universe: | NNNNNN | |
| Federal Universal Waste: | N | |
| Federal Indicator: | | |
| Hsm: | N | |
| Gpra Permit Baseline: | Not on the Baseline | |
| Gpra Renewals Baseline: | Not on the Baseline | |
| Permit Renewal Workload: | | |
| Permit Workload Universe: | | |
| Permit Progress Universe: | | |

Map ID 1: RCRA - 5213 FLOWER DR



| Post Closure Workload Universe: | |
|------------------------------------|------------|
| Closure Workload Universe: | |
| Under Discretionary Auth Universe: | N |
| Environmental Control Indicator: | N |
| Institutional Control Indicator: | N |
| Human Exposure Indicator: | N |
| Groundwater Controls Indicator: | N |
| Full Enforcement Universe: | |
| Snc Universe: | N |
| Unaddressed Snc: | N |
| Addressed Snc: | N |
| Snc With Compliance Sched: | N |
| Financial Assurance Required: | |
| Handler Date Of Last Change: | 2012-10-18 |

Enforcements

| ld Number: | TXR000079277 |
|--------------------------|------------------|
| Activity Location: | TX |
| Enforcement Identifier: | 1 |
| Enforcement Type: | HQ120 |
| Enforcement Desc: | WRITTEN INFORMAL |
| Enforcement Agency: | S |
| Enforcement Action Date: | 10/03/2011 |
| Pmp Amount: | |
| Fmp Amount: | |
| Fsc Amount: | |
| Scr Amount: | |

Evaluations

| ld Number: | TXR000079277 |
|------------------------|----------------------------------|
| Activity Location: | TX |
| Evaluation Identifier: | 1 |
| Evaluation Type: | CEI |
| Evaluation Desc: | COMPLIANCE EVALUATION INSPECTION |
| Evaluation Agency: | State |
| Evaluation Start Date: | 09/28/2011 |
| Found Violation: | Υ |

Violations

| Id Number: | TXR000079277 |
|----------------------------|---|
| Activity Location: | TX |
| Violation Type: | XXS |
| Violation Type Desc: | State Statutory or Regulatory requirements that are broader-in-scope than the federal RCRA requirements |
| Viol Determined By Agency: | S |
| Date Violation Determined: | 09/28/2011 |
| Actual Rtc Date: | 10/03/2011 |
| Scheduled Compliance Date: | |

Map ID 1: RCRA - 5213 FLOWER DR



Sites in Map ID 1 Cluster

| Dataset | Facility Site Name | Facility Site Address | Page # |
|---------|---|-------------------------------|--------|
| HW | CALLE REO YEAPACHIC JUAREZ | 5213 FLOWER DR, EL PASO 79905 | 19 |
| RCRA | TRANSPORTES UNION - CALLE REO YEAPACHIC JUAREZ | 5213 FLOWER DR, EL PASO 79905 | 20 |

End of RCRA Section

End of Mapped Sites Details Section

Unmapped Site: ERNS (1257981)



| Unmapped Site NRC Report #: 1257981 TX-375, EL PASO, TX | ERNS - Emergency Response Notification System | Source: EPA/National Response Center Banks ID: 1257981 |
|--|--|--|
| Incident Date Time: | 9/12/2019 6:20 | |
| Responsible Company: | UNITED PETROLEUM TRANSPORTS | |
| Source: | TELEPHONE | |

ERNS Details

| Additional Info: | |
|--------------------------|--|
| Additional Medium Info: | |
| Any Fatalities: | Υ |
| Description Of Incident: | CALLER REPORTING A TRACTOR TRAILER TANKER ON FIRE, RELEASING APPROXIMATELY 8000 GALLONS OF ETHANOL ON THE ROADWAY. THE INCIDENT IS STILL ON GOING, THE CAUSE IS UNKNOWN, INVESTIGATION IS UNDERWAY. LOCAL FIRE AND POLICE ON LOCATION, CONTRACTOR ENROUTE FOR CLEAN UP. ROADWAY IS CLOSED IN BOTH DIRECTIONS. CALLER REPORTING ONE FATALITY AT TIME OF INCIDENT. |
| Desc Remedial Action: | CLEAN UP CREW ENROUTE, INVESTIGATION UNDERWAY |
| Incident Cause: | TRANSPORT ACCIDENT |
| Incident Date Time: | 9/12/2019 6:20 |
| Incident Location: | |
| Medium Desc: | LAND |
| Number Fatalities: | 1.0 |
| Pipeline Type: | |
| Railroad Name: | |
| Responsible Company: | UNITED PETROLEUM TRANSPORTS |
| Seqnos: | 1257981 |
| Source: | TELEPHONE |
| Type Of Incident: | MOBILE |

Materials Involved

| Name Of Material: | ETHYL ALCOHOL |
|-------------------|---------------|
| Seqnos: | 1257981 |

End of Unmapped Sites Details Section



| Dataset | Source | Dataset Description | Update Schedule | Requested Date | Received Date | Update Date | Source Update Date |
|--|--------|---|--------------------|-------------------|---------------|----------------|--------------------------|
| RCRA COR - RCRA - Corrective | Cource | These sites are registered hazardous waste generators or handlers that fall under the Resource Conservation and Recovery Act | Concadio | Date | Date | Date | Date |
| Actions (FED) | EPA | (RCRA) and subject to corrective action activity. | Quarterly | 2024-01-18 | 2024-01-18 | 2024-01-24 | 2024-01-16 |
| RCRA TSD - RCRA - Treatment, Storage, Disposal (FED) | EPA | This database lists all treatment, storage and disposal of hazardous material sites that fall under the Resource Conservation and Recovery Act (RCRA). All hazardous waste TSD facilities are required to notify EPA of their existence. | Quarterly | 2024-01-18 | 2024-01-18 | 2024-01-24 | 2024-01-16 |
| RCRA - RCRA (FED) | EPA | This database lists all sites that fall under the Resource Conservation and Recovery Act (RCRA) and are not classifiable as treatment, storage, disposers of hazardous material, hazardous waste generator or subject to corrective action activity. | Quarterly | | 2024-01-18 | | |
| CER NPL - CERCLIS - National Priority List (FED) | EPA | NPL is the list of high priority hazardous waste sites in the United States eligible for long-term remedial action financed under the federal Superfund program or SEMS database (formerly known as the CERCLIS database). The EPA will only add sites to the NPL list based upon completion of the Hazard Ranking System (HRS) screening, public solicitation of comments about the proposed site, and after all comments have been addressed. | Quarterly | | 2024-01-03 | | |
| CER - CERCLIS (FED) | EPA | The EPA maintains the SEMS database to track sites under the Comprehensive Environmental Response, Compensation, and Liability Act, a federal law designed to clean up abandoned hazardous waste sites. These sites are either proposed, listed or under review currently to be a part of the National Priority List. | Quarterly | 2024-01-03 | 2024-01-03 | 2024-01-03 | 2023-12-26 |
| CER NFRAP - CERCLIS - No Further Remedial Action Planned (FED) | EPA | From the Superfund Enterprise Management System (SEMS) database No Further Remedial Action Planned or NFRAP have been removed from the listing. NFRAP sites may be sites where, following an initial investigation, no contamination was found, contamination was removed quickly without the site being placed on the NPL, or the contamination was not serious enough to require Federal Superfund action or NPL consideration. | Quarterly | 2024-01-03 | 2024-01-03 | 2024-01-03 | 2023-12-26 |
| CER DNPL - CERCLIS - Delisted National Priority List (FED) | EPA | DNPL is a list of all sites that have been deleted from the EPA NPL list (SEMS database). These sites are taken off the NPL list usually due to no further response or remedial action being required on them. Notices to delete NPL sites are published in the Federal Register and become effective unless the EPA receives significant adverse or critical comments during the 30-day public comment period. | Quarterly | 2024-01-03 | 2024-01-03 | 2024-01-03 | 2023-12-26 |
| FED BF - Federal Brownfield (FED) | EPA | A listing of sites that assist the EPA in collecting, tracking, and updating information of sites in relation to the Small Business Liability Relief and Brownfields Revitalization Act. These sites are real property that is either abandoned or underutilized where redevelopment or expansion is complicated by real or perceived environmental contamination. | Quarterly | 2024-01-15 | 2024-01-15 | 2024-01-24 | 2024-01-15 |



| | | | Update | Requested | Received | Update | Source Update |
|---|------------------------------------|--|-----------|------------|------------|------------|------------------|
| Dataset | Source | Dataset Description | Schedule | Date | Date | Date | Date |
| RCRA VSG - RCRA - Very Small Quantity Generators (FED) | EPA | The EPA regulates all Hazardous Waste Generators subject to the Resource Conservation and Recovery Act (RCRA). They are classified by the quantity of hazardous waste generated. A Very Small Quanity Generator (VSG) generates less than 100 kg of waste per month. | Quarterly | 2024-01-18 | 2024-01-18 | 2024-01-24 | 2024-01-16 |
| RCRA SQG - RCRA - Small Quantity Generators (FED) | EPA | The EPA regulates all Hazardous Waste Generators subject to the Resource Conservation and Recovery Act (RCRA). They are classified by the quantity of hazardous waste generated. A Small Quantity Generator (SQG) generates between 100kg and 1,000 kg of waste per month. | Quarterly | 2024-01-18 | 2024-01-18 | 2024-01-24 | 2024-01-16 |
| FED IC - Federal Institutional Control (FED) | EPA | This is a listing of Brownfield Management System (BMS) sites that have had Institutional Controls (ICs) placed on them. ICs are administrative restrictions, such as legal controls, that help minimize the potential for human exposure to known contamination by ensuring appropriate land or resource use. ICs are meant to supplement Engineering Controls and will rarely be the sole remedy at a site. ICs are a type of Activity and Use Limitation (AUL). | Quarterly | 2024-01-15 | 2024-01-15 | 2024-01-24 | 2024-01-15 |
| FED EC - Federal Engineering Control (FED) | EPA | This is a listing of Brownfield Management System (BMS) sites that have had Engineering Controls (ECs) placed on them. ECs are physical methods or modifications put into place on a site to reduce or eliminate the possibility of human exposure to known contamination. ECs are a type of Activity and Use Limitation (AUL). | Quarterly | 2024-01-15 | 2024-01-15 | 2024-01-24 | 2024-01-15 |
| ERNS - Emergency Response Notification System (FED) | EPA/National Response Center | ERNS is a national database used to store information on unauthorized releases of oil and hazardous substances that have been reported to the National Response Center since 2001. The NRC is the sole federal point of contact for reporting oil and chemical spills. Prior to 2001 this information was maintained by the EPA. | Annually | | | 2024-01-29 | |
| RCRA LQG - RCRA - Large Quantity Generators (FED) | EPA | The EPA regulates all Hazardous Waste Generators subject to the Resource Conservation and Recovery Act (RCRA). They are classified by the quantity of hazardous waste generated. A Large Quantity Generator (LQG) generates over 1,000 kg of waste per month. | Quarterly | 2024-01-18 | 2024-01-18 | 2024-01-24 | 2024-01-16 |
| ST PL - State National Priority List (TX) | TCEQ | This database contains sites determined by the TCEQ that may constitute an imminent and substantial endangerment to public health and safety or to the environment due to a release or threatened release of hazardous substances into the environment. | Quarterly | 2023-07-10 | 2023-07-10 | 2024-01-23 | 2023-07-10 |
| LPST - Leaking Petroleum Storage Tank (TX) | TCEQ | This database contains information on leaking storage tanks, equipment failures, compliance, and releases in the state. | Quarterly | 2023-06-09 | 2023-03-01 | 2024-01-25 | 2023-03-01 |
| VCP - Voluntary Cleanup Program (TX) | TCEQ | This database contains sites from the Voluntary Cleanup Program (VCP). The VCP records contain information on contaminated sites that private parties have cleaned up through assistance from the State in the form of administrative, technical, and legal incentives. | Quarterly | 2023-07-10 | 2023-07-12 | 2024-01-23 | 2023-07-12 |



| Dataset | Source | Dataset Description | Update Schedule | Requested Date | Received Date | Update Date | Source Update Date |
|---|--------|--|--------------------|-------------------|------------------|----------------|--------------------------|
| VCP - Voluntary Cleanup Program | | This database contains sites from the Innocent Operator Program (IOP). The IOP records are sites that have received certificates from the State acknowledging that their property is contaminated as a result of a release or migration of contaminants from a source or sources not located on the property, and they did not cause or contribute to the source or sources of | | | | | |
| (TX) | TCEQ | contamination. The Railroad Commission of Texas Voluntary | Quarterly | 2023-07-10 | 2023-07-12 | 2024-01-23 | 2023-07-12 |
| VCP - Voluntary Cleanup Program (TX) | RRC | Cleanup Program provides an incentive to remediate Oil & Gas related pollution by participants as long as they did not cause or contribute to the contamination. | Quarterly | 2023-05-04 | 2023-05-09 | 2024-01-25 | 2023-05-09 |
| BF - State Brownfield (TX) | RRC | The Railroad Commission of Texas' Voluntary Cleanup Program (RRC-VCP) provides an incentive to remediate Oil & Gas related pollution by participants as long as they did not cause or contribute to the contamination. Applicants to the program receive a release of liability to the state in exchange for a successful cleanup. | Quarterly | 2023-05-04 | 2023-05-09 | 2024-01-25 | 2023-05-09 |
| BF - State Brownfield (TX) | TCEQ | Brownfield sites are former industrial properties that lie dormant or underutilized due to liability associated with real or perceived contamination. In Texas, the TCEQ, in close partnership with the EPA and other federal, state, and local redevelopment agencies, and stakeholders, is facilitating cleanup, transferability, and revitalization of Brownfield's through the development of regulatory, tax, and technical assistance tools. | Quarterly | 2023-05-04 | 2023-05-04 | 2024-01-23 | 2023-05-04 |
| SW - Solid Waste (TX) | TCEQ | The SWLF database contains records of municipal solid waste facilities that may accept various types of municipal solid waste for processing or disposal, depending on the type of facility. A Municipal Solid Waste facility may also accept certain special wastes and non-hazardous industrial solid wastes if approved by the TCEQ executive director. | Quarterly | 2023-05-04 | 2023-05-04 | 2024-01-23 | 2023-04-28 |
| SW - Solid Waste | TCEQ | This database is a listing of closed and abandoned municipal solid waste landfills. The sites included are either unauthorized (UNUM_) or permitted (PERMAPP_). | Historical | | | 2011-03-06 | |
| VCP - Voluntary Cleanup Program (TX) | RRC | The Operator Cleanup Program (OCP) under the Site Remediation Section is tasked with oversight of complex pollution cleanups performed by the oil and gas industry. Complex sites include those that occur in sensitive environmental areas as defined by 16 TAC3.91 (SWR 91) and may require site specific cleanup levels based on risk. | | | | 2024-02-12 | |
| VCP - Voluntary Cleanup Program (TX) | TCEQ | The Texas Groundwater Protection Committee (TGPC) Joint Groundwater Monitoring and Contamination Report, SFR-56 lists all active and inactive groundwater contamination cases in the state and their enforcement status | Quarterly | 2023-08-14 | 2023-08-14 | 2024-02-12 | 2023-08-14 |
| LPST - Leaking Petroleum Storage Tank (TR6) | EPA | The Tribal LUST database (maintained by EPA Region 6) provides information on leaking underground storage tank on tribal lands in Louisiana, Arkansas, Oklahoma, New Mexico and Tribal Nations. | Quarterly | 2024-02-01 | 2024-02-01 | 2024-02-02 | 2024-10-25 |



| | | | | | | | OF THE BANG GROUP |
|---|--------|--|--------------------|-------------------|------------------|----------------|--------------------------|
| Dataset | Source | Dataset Description | Update Schedule | Requested Date | Received Date | Update Date | Source Update Date |
| MSD - Municipal Setting Designation (TX) | TCEQ | TCEQ defines a Municipal Settings Designation (MSD) as an official state designation given to a property within a municipality or its extraterritorial jurisdiction that certifies that designated groundwater at the property is not used as potable water, and is prohibited from future use as potable water because that groundwater is contaminated in excess of the applicable potable-water protective concentration level. The prohibition must be in the form of a city ordinance, or a restrictive covenant that is enforceable by the city and filed in the property records. | Quarterly | 2023-06-09 | 2023-06-12 | 2024-01-23 | 2023-06-12 |
| PST - Petroleum Storage Tank (TR6) | EPA | The Tribal UST database (maintained by EPA Region 6) provides underground storage tank information on tribal lands in Louisiana, Arkansas, Oklahoma, New Mexico and Tribal Nations. | Quarterly | 2024-02-01 | 2024-02-01 | 2024-02-02 | 2024-10-24 |
| DRYC - Dry Cleaner (TX) | TCEQ | Dry Cleaner data houses both the DCRP Program information and PERC information released by the TCEQ. The DCRP database contains records funded for state-lead clean up of dry cleaner related contaminated sites. The DCRP administers the Dry Cleaning Facility Release Fund to assist with remediation of contamination caused by dry cleaning solvents. There are two listings from this program: LIST#1 - A historic listing of any facility that registered with the DCRP indicating whether or not the facility has used Perchloroethylene (PERC) in the past. LIST#2 - A Prioritization list of dry cleaner sites Facilities on this list will be investigated in order to determine the existence and or extent of possible contamination. Facilities which are not current on their DCRP payments get dropped from the program. | Quarterly | 2023-06-09 | 2023-06-09 | 2024-01-23 | 2022-09-01 |
| HW - Hazardous | | This database contains information on facilities which store, process, or dispose of hazardous waste as maintained by the Industrial and | · | | | | |
| Waste (TX) IC - State Institutional Control (TX) | RRC | Hazardous Waste Permits section of the TCEQ. The Railroad Commission of Texas Voluntary Cleanup Program provides an incentive to remediate Oil & Gas related pollution by participants as long as they did not cause or contribute to the contamination. | Quarterly | | | 2024-01-23 | |
| EC - State Engineering Control (TX) | TCEQ | This database includes Voluntary Cleanup Program (VCP) or Innocent Operator Program (IOP) sites that have been remediated and have had Engineering Controls (ECs) placed on them. ECs are physical methods or modifications put into place on a site to reduce or eliminate the possibility of human exposure to known contamination. | Quarterly | 2023-07-10 | 2023-07-12 | 2024-01-23 | 2023-07-12 |
| HW - Hazardous Waste (TX) | TCEQ | The mission of the TCEQ's industrial and hazardous waste (IHW) corrective action program is to oversee the cleanup of sites contaminated from industrial and municipal hazardous and industrial nonhazardous wastes. | Quarterly | 2023-07-10 | 2023-04-06 | 2024-01-23 | 2023-03-31 |
| HW - Hazardous Waste (TX) | TCEQ | This dataset lists various court orders affecting a site, including Notices of Enforcement and Administrative Orders. | Quarterly | 2023-08-11 | 2023-08-11 | 2024-02-12 | 2023-07-15 |
| PST - Petroleum Storage Tank (TX) | TCEQ | This database contains information on above and underground storage tanks, compliance, and releases in the state. | Quarterly | 2024-01-02 | 2024-01-02 | 2024-01-23 | 2023-12-07 |



| Dataset | Source | Dataset Description | Update Schedule | Requested Date | Received Date | Update Date | Source Update Date |
|---|--------|---|--------------------|-------------------|------------------|----------------|--------------------------|
| IC - State Institutional Control (TX) | TCEQ | This database includes Voluntary Cleanup Program (VCP) or Innocent Operator Program (IOP) sites that have been remediated and have had Institutional Controls (ICs) placed on them. ICs are administrative restrictions, such as legal controls, that help minimize the potential for human exposure to known contamination by ensuring appropriate land or resource use. | Quarterly | 2023-07-10 | 2023-07-12 | 2024-01-23 | 2023-07-12 |

Disclaimer



The Banks Environmental Data Regulatory Database Report was prepared based upon data obtained from State, Tribal, and Federal sources known to Banks Environmental Data at the time the data was obtained. Great care has been taken by Banks in obtaining the best available data from the best available sources. However, there is a possibility that there are sources of data applicable or pertaining to this report's target property, and/or surrounding properties, to which Banks does not have access or has not accessed. Furthermore, although Banks Environmental Data performs quality assurance and quality control on all data, including data it obtains, Banks recognizes that inaccuracies in data from these sources may, and do, exist; accordingly, inaccurate data may have been used or relied upon in the preparation of this report. Even though Banks Environmental Data performs a thorough and diligent search to locate and fix any inaccuracies in the data relied upon in the preparation of this report, Banks cannot guarantee or warrant the accuracy of the locations, information, data, or report. The purchaser of this report accepts this report "as is" and assumes all risk related to any potential in accuracy contained in the report or not reported in it, whether due to a reliance by Banks Environmental Data on inaccurate data, or for any other reason [including but not limited to the negligence or express negligence of Banks Environmental Data]. If this report is being used for the Records Review section of a Phase I Site Assessment according to the ASTM 1527-21, for EPA's All Appropriate Inquiry, or for any other purpose (public or private), all liability and responsibility is assumed by the Environmental Professional or other individual or entity acquiring the report.



List of Potential Public Review POCS for Clardy Fox Project

Public review of the Draft Environmental Assessment (DEA) was held from December 15, 2024 until January 15, 2025. The DEA was made available electronically at the Albuquerque District website and paper copies of the DEA were available for review at the Clardy Fox Library (5515 Robert Alva Ave, El Paso, TX 79905) and the TecH2O Center (10751 Montana Ave, El Paso, TX 79936). Letters inviting comment were sent to the agencies and entities listed below. The U.S. International Boundary and Waters Commission and the Texas Parks and Wildlife acknowledged receipt of the DEA but had no comments on the proposed project.

Federal Agencies

Federal Emergency Management Agency

Larry Voice, Senior Engineer, Mitigation Division, FEMA Region 6 larry.voice@fema.dhs.gov

Office: (940) 898-5419 Mobile: (940) 435-9078

International Boundary and Water Commission, U.S. Section (USIBWC)

Dr. Gilbert Anaya gilbert.anaya@ibwc.gov 4191 N. Mesa, El Paso, TX 79902 915-832-4710

US Fish and Wildlife Service –Texas Coastal Ecological Services Field Office

Ms. Dawn Gardiner, Field Supervisor, U.S. Fish and Wildlife Service dawn_gardiner@fws.gov
Texas Coastal ES Field Office, Alamo sub-office 3325 Green Jay Road Alamo, Texas 78516

USEPA Region 6

Mr. Robert Houston, Staff Director

Houston.Robert@epa.gov
Communities, Tribes and Environmental Assessment
Office of the Regional Administrator, U.S. EPA Region 6
1201 Elm Street, Suite 500
Dallas, Texas 75270-2102

State

Texas Commission on Environmental Quality (TCEQ)

Kent Waggoner, Regional Director, Region 6, El Paso kent.waggoner@tceq.texas.gov (512) 239-3500 401 E. Franklin Ave, Ste 560 El Paso TX 79901-1212 Main Line: 915-834-4949

Texas Department of Transportation

Tomas Trevino, P.E., District Engineer, El Paso

Tomas.trevino@txdot.gov

915-790-4204

13301 Gateway West, El Paso, TX 79928

cc: Antonio Santana District Hydraulics Engineer Antonio.Santana@txdot.gov

Texas Parks and Wildlife Department

Jessica Schmerler, Ecological and Environmental Planning Program Jessica.Schmerler@tpwd.texas.gov

Lois Balin, Urban Wildlife Biologist lois.balin@tpwd.texas.gov

Local

City of El Paso Floodplain Administrator

Kareem Dallo, P.E., CFM, CNU-A Engineering Division Manager & Floodplain Administrator dallokf@elpasotexas.gov (915) 212-1560

County Commissioner Precinct 2

David Stout 915-546-2111 Commissioner2@epcounty.com

District 2 City Representative

Josh Acevedo 915-212-0002 <u>District2@elpasotexas.gov</u>

Nearest Library

Clardy Fox Library 5515 Robert Alva Ave., El Paso, TX 79905 915-212-0456

Neighborhood Associations

Washington- Delta Neighborhood Association Ms. Cynthia Renteria 915-637-3026 Mr. Brian Lopez 915-996-3778



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AFFIDAVIT OF PUBLICATION

Gretchen Byram El Paso Water Utilities 1154 Hawkins Blvd El Paso TX 79925

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12/15/2024

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Pump Station, El Paso,
Texas
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ster Utilities (EPWale
ve campleled a Dra

Environmental Resources Section Atin: CESPA-PM-LE (Ms. Dana Price) Albuquerque, New Mexico 87109-3435 per copies of the DEA ore

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El Paso, Saturday, December 14, 2025. 7 AM to 1 PM., 1400 Elm Street, **BIG YARD SALE. MANY** LAMPS, FOOTSTOOLS, SMALL TABLES, CHRIST-MAS STUFF, GLASSWARE, CLOCK RADIO, TOILET,

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Responses must be received by UMC El Paso Purchasing Interim Life Safety Measurements. Qualified Department no later than January 27, 2025 until 2:00
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University Medical Center of



Center Procurement Portal, https://umcelpaso.bonfirehub .com/portal, also can be found on our web page https://www.umcelpaso.org/do-business-with-umc. A mandatory pre-submittal meeting is scheduled on December 18, 2024 at 2:00 PM MT in the Engineering

Conference Room. Last day to submit questions for this RFP is January 7, 2025 until 2:00 PM MT

Floor

El Paso reserves the right to accept or reject any or all responses. All questions regarding this RFP may be

to: bidsquestions@umcelpaso.org or through Procurement Portal. 10829655 Dec. 8, 15, 2024

Public Notices

Notice of Availability Draft Environmental Assessment, Clardy Fox Pump Station, El Paso,

The U.S. Army Corps of Engineers (Corps), Albuquerque District and El Paso Water Utilities (EPWater) have completed a Draft Environmental Assessment (DEA) entitled "Clardy Fox Pump Station, El Paso, Texas". The Corps, in cooperation with and at the request of EPWater, is planning to improve the stormwater pumping capacity of the pump station to reduce the potential for flooding within the Clardy Fox community along Cesar E. Chavez Highway on the southern city limits. The proposed work would include the construction of a new back-up generator platform, new transformer and electric control room, rerouting of electrical components, and installation of three larger water pumps. These improvements would more than double the pumping capacity of the existing faciliity during period of signifi-cant rainfall so stormwater can more efficiently be discharged into the Rio Grande and out of the local draine and our of the local housing community. The duration of the proposed construction would be nine months and is expected to

rnorms and is expected to start in the fall of 2025.

The DEA is electronically available for viewing and downloading at the Albuquerque District website (under "FONSI/ Environmental Assessments") at: (under "FONSI/ Environ-mental Assessments") at: https://www.spa.usace.arm y.mil/Missions/Environment al/Environmental-Complian ce-Documents/Environment

Public Notices

Public Notices

<u>al-Assessments-FONSI/</u>. A hard copy will be sent upon

The draft EA and FONSI will be available for public review from Dec. 15, 2024 until Jan. 15, 2025. Written comments may be emailed to <u>USACEProjectsEIPaso</u> <u>Texas@usace.army.mil.</u>

or sent by postal mail to: U.S. Army Corps of Engi-

Albuquerque District Resources Environmental

Section
Attn: CESPA-PM-LE (Ms. Dana Price)

Albuquerque, New Mexico 87109-3435 Paper copies of the DEA are

also available for review at: Clardy Fox Library, 5515 Robert Alva Ave., El Paso, TX 79905

TecH2O Center, 10751 Montana Ave., El Paso, TX 79936 For more information,

please contact Ms. Dana Price, USACE, (505) 342-3378 or <u>USACEProjectsEIPaso</u> <u>Texas@usace.army.mil</u> December 15,2024 10846066

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Public Notices

Mesilla Valley Public Housing Authority: Executive Direc-

Mesilla Valley Public Housing Authority (MVPHA) is seeking a qualified and dynamic individual to serve as its Executive Director. This key leadership position is responsible for overseeing the day-to-day operations, property management, public housing and voucher program administration, financial, compliance, and community relations for the housing authority. The Executive Director reports to the five-member board of commissioners appointed by the City of Las Cruces and Dona Ana County Board of County Commissioners.

MVPHA owns, operates, and manages a portfolio of approximately 1,000 units and 1,700 vouchers. This consists of 248 public housing units, 40 Section 8 New Construction units, 681 tax credit/non-subsidized units, and 1,666 HCV vouchers (including 80 VASH Vouchers). Overall, MVPHA serves approximately 6,000 low-income families and individuals in its area of operation. MVPHA has a budget of approximately \$11M and a staff of 30 employees. MVPHA is planning to "reposition" a significant component of its public housing units as part of redevelopment of its main campus area near downtown/central Las Cruces.

Applicants must have a Bachelor's degree, with a degree in public administration, business administration, urban planning, or a related field preferred. Applicants should have at least five years of experience in the affordable and/or multifamily housing field, or a related field, such as public administration, with expertise in federal housing program administration preferred.

The position comes with a competitive salary in the anticipated range of \$115,000 to \$135,000, with benefits, commensurate with the candidate's experience.

Interested applicants must submit a cover letter, application, resume, and any additional information about them-selves they believe is relevant for consideration to MVPHA through its outside counsel, Mendel Blumenfeld & Pulido,

The deadline for the submission of applications is 5:00 p.m., Mountain Time, on Monday, January 13, 2024.

Applications and information about MVPHA may be obtained online at the following link: https://www.dropbox.com/scl/fo/m5tnojfyyncm24hwypiw3/ AHKmQxMZrusV6URBrX4f3ew?rlkey=azgiugmtqa3vhfgb1

Applications must be submitted via email to Robert L. Blumenfeld, bblu@acaciapark.com. December 15 2024 LACO0206817

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Washers, Dryers, Refrigera-tors, Stoves, Dishwashers & Garbage Disposals, Se Habla From: Gilbert Anaya

To: Price, Dana M CIV USARMY CESPA (USA)

Cc: Frank Fisher

Subject: [Non-DoD Source] RE: El Paso, TX Project Review: Draft EA for Clardy Fox Pump Station

Date: Monday, December 16, 2024 11:22:34 AM

Hi Dana,

Thank you for providing, we will review the EA and get back to you if needed.

Regards, Gilbert

From: Price, Dana M CIV USARMY CESPA (USA) <dana.m.price@usace.army.mil>

Sent: Friday, December 13, 2024 1:12 PM **To:** Gilbert Anaya <gilbert.anaya@ibwc.gov> **Cc:** Frank Fisher <frank.fisher@ibwc.gov>

Subject: El Paso, TX Project Review: Draft EA for Clardy Fox Pump Station

Good afternoon, Dr. Anaya,

The U.S. Army Corps of Engineers, in collaboration with El Paso Water, is planning a project to improve the Clardy Fox Pump Station in southeast El Paso. A map and project description is provided in the attached letter. We have prepared a draft Environmental Assessment (EA) for public review, available on the Albuquerque District website at

https://www.spa.usace.army.mil/Missions/Environmental/Environmental-Compliance-Documents/Environmental-Assessments-FONSI/.

The public review will extend from December 15, 2024, until **January 15, 2025**. Please reach out with any questions.

Thank you, Dana

Dana M. Price (she/her)
Biologist
Environmental Resources Section
U.S. Army Corps of Engineers, Albuquerque District

Office: (505) 342-3378

Telework/Cell: (505) 417-9787

From: <u>Jessica Schmerler</u>

To: Price, Dana M CIV USARMY CESPA (USA)

Cc: Lois Balin

Subject: [Non-DoD Source] RE: El Paso, TX Project review: Draft EA for Clardy Fox Pump Station

Date: Wednesday, January 15, 2025 3:15:59 PM

Hi Dana,

The TPWD Ecological and Environmental Planning Program does not have any comments on the Draft EA for the proposed Clardy Fox Pump Station Project. Thank you for coordinating this project with our program.

I hope you are doing well!

Thanks, Jessica

Jessica E. Schmerler, CWB
Environmental Review Biologist
Ecological & Environmental Planning Program
Texas Parks and Wildlife Department
(512) 389-8054

From: Price, Dana M CIV USARMY CESPA (USA) <dana.m.price@usace.army.mil>

Sent: Friday, December 13, 2024 12:42 PM **To:** Lois Balin <Lois.Balin@tpwd.texas.gov>

Cc: WHAB < WHAB@tpwd.texas.gov>; Jessica Schmerler < Jessica.Schmerler@tpwd.texas.gov>

Subject: El Paso, TX Project review: Draft EA for Clardy Fox Pump Station

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Good afternoon, Lois,

I'm addressing this review request to you because I've worked with you on previous projects in the El Paso area. I'm also sending this to the Wildlife Habitat Assessment Program.

The U.S. Army Corps of Engineers, in collaboration with El Paso Water, is planning a project to improve the Clardy Fox Pump Station in southeast El Paso. A brief project description is provided in the attached letter. We have prepared a draft Environmental Assessment (EA) for public review, available on the Albuquerque District website at

https://www.spa.usace.army.mil/Missions/Environmental/Environmental-Compliance-Documents/Environmental-Assessments-FONSI/. The Corps has determined that no listed species or critical habitats would be affected by the proposed action. The comment period is from Dec. 15, 2024 to Jan. 15, 2025.

Please let me know if you have questions. Thank you, Dana

Dana M. Price (she/her)
Biologist
Environmental Resources Section
U.S. Army Corps of Engineers, Albuquerque District
Office: (505) 342-3378

Telework/Cell: (505) 417-9787

From: Reyes, Ernesto

To: <u>Price, Dana M CIV USARMY CESPA (USA)</u>

Cc: <u>delaGarza, Laura</u>

Subject: [Non-DoD Source] Clardy Fox Pump Station

Date: Wednesday, February 19, 2025 9:11:52 AM

Ms. Dana M. Price,

We received your December 17, 2024 letter regarding effects of a proposed pump station on federally listed species in El Paso County, Texas. This action also was evaluated for impacts to wetlands and other federal fish and wildlife trust resources.

The U.S. Army Corps of Engineers (Corps), Albuquerque District and El Paso Water Utilities (EP Water) have completed the Draft Environmental Assessment (DEA) entitled "Clardy Fox Pump Station, El Paso, Texas". The Corps, in cooperation with and at the request of EP Water, is planning to improve the stormwater pumping capacity of the pump station to reduce the potential for flooding within the Clardy Fox community along Cesar E. Chavez Highway on the southern city limits bordering Mexico. The proposed work would include the construction of a new back-up generator platform, new electric control room, installation of three larger water pumps and a rerouting of electrical components to the new transformer location. These improvements would more than double the pumping capacity of the existing facility during periods of significant rainfall so water can more efficiently be discharged into the Rio Grande and out of the local housing community. The duration of the proposed construction would be nine months and is expected to start in the fall of 2025.

To avoid or minimize impacts to birds protected by the MBTA, the Service recommends conducting bird surveys no more than five days prior to ground disturbing activities or mechanical clearing of brush and trees between March 15 and September 15. Surveys should include searches for birds, nests, and eggs. The U.S. Fish and Wildlife Service (Service) recommends leaving a buffer of vegetation (≥100 feet (30.5 meters) around songbird nests detected until young have fledged or the nest is abandoned. Other species such as water birds or raptors require larger buffer distances of 500 feet or more.

The Corps has determined that the project activity would have no effect on southwestern willow flycatcher (*Empidonax traillii extimus*), western yellow-billed cuckoo (*Coccyzus americanus occidentalis*), and Sneed's pincushion cactus (*Escobaria sneedii var. sneedii*). The Service does not provide concurrence for "no effect" determinations, but by making a determination, we believe the Corps has complied with Section 7(a)(2) of the Endangered Species Act of 1973, as amended.

Ernesto Reyes

Fish and Wildlife Biologist
U.S. Fish and Wildlife Service
Texas Coastal and Central Plains Ecological Service
Alamo Sub-Office

3325 Green Jay Rd Alamo, Texas 78516 O - 956-307-5132 C - 361-533-6057





List of Contacted Agencies

Federal Agencies

Federal Emergency Management Agency

Larry Voice, Senior Engineer, Mitigation Division, FEMA Region 6 larry.voice@fema.dhs.gov

Office: (940) 898-5419 Mobile: (940) 435-9078

Federal Highway Administration

Thomas Beeman thomas.beeman@dot.gov
Area Engineer, El Paso District (Abilene, El Paso, Lubbock, Odessa) (512) 536-5967

International Boundary and Water Commission, U.S. Section (USIBWC)

Apurba Borah, Ph.D., P.E., PMP, CFM Lead Hydraulic Engineer apurba.borah@ibwc.gov

Dr. Gilbert Anaya gilbert.anaya@ibwc.gov 4191 N. Mesa, El Paso, TX 79902 915-832-4710

United States Border Patrol

Kamal Otman
kamal.k.otman@cbp.dhs.gov
Program Manager, TI EI Paso and Big Bend Sectors
US Border Patrol
DHS/CBP
Program Management Office Directorate
(202) 819-6074 Gov Cell
cc: gabriel.g.olivas@cbp.dhs.gov

US Fish and Wildlife Service -Texas Coastal Ecological Services Field Office

Ms. Dawn Gardiner, Field Supervisor, U.S. Fish and Wildlife Service dawn_gardiner@fws.gov
Texas Coastal ES Field Office, Alamo sub-office
3325 Green Jay Road
Alamo, Texas 78516

USDA NRCS El Paso Service Center

Margaret Gannon, Urban Conservationist

<u>Margaret.Gannon2@usda.gov</u>

1190 Don Haskins Suite E2 El Paso, TX, 79936

Mobile Number: (915) 539-1497 Office Number: (915) 261-1443

USEPA Region 6

Mr. Robert Houston, Staff Director

<u>Houston.Robert@epa.gov</u>

Communities, Tribes and Environmental Assessment

Office of the Regional Administrator, U.S. EPA Region 6

1201 Elm Street, Suite 500

Dallas, Texas 75270-2102



State

Texas Commission on Environmental Quality (TCEQ)

Kent Waggoner, Regional Director, Region 6, El Paso kent.waggoner@tceq.texas.gov (512) 239-3500 401 E. Franklin Ave, Ste 560 El Paso TX 79901-1212

Main Line: 915-834-4949

Texas Department of Transportation

Tomas Trevino, P.E., District Engineer, El Paso

<u>Tomas.trevino@txdot.gov</u>

915-790-4204

13301 Gateway West, El Paso, TX 79928

cc: Antonio Santana District Hydraulics Engineer Antonio.Santana@txdot.gov

Texas Parks and Wildlife Department

Jessica Schmerler, Ecological and Environmental Planning Program Jessica.Schmerler@tpwd.texas.gov

Lois Balin, Urban Wildlife Biologist lois.balin@tpwd.texas.gov

Local

City of El Paso Floodplain Administrator

Kareem Dallo, P.E., CFM, CNU-A Engineering Division Manager & Floodplain Administrator dallokf@elpasotexas.gov (915) 212-1560

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Open Space Advisory Board (OSAB)

Kevin Smith smithkw@elpasotexas.gov Planning and Inspections 915-212-1566 300 N. Campbell El Paso, Texas 79901



List of Contacted Tribes by ESSCO

• APACHE TRIBE OF OKLAHOMA

P.O. Box 1330 Anadarko, OK 73005

Mr. Bobby Komardley

Chairman bkomardley@outlook.com

Mr. Sterling Chalepah

Environmental Gap Technician sterling.chalepah@apachetribe.org

COMANCHE NATION

P.O. Box 908 Lawton, OK 73502

Ms. Martina Minthorn

Tribal Historic Preservation Officer martina.minthorn@comanchenation.com

Mr. Mark Woommavovah

Chairman jennifer.rodriguez@comanchenation.com

FORT SILL APACHE

43187 US Highway 281 Apache, OK 73006-8038

Ms. Lori Gooday Ware

Chairwoman lori.g.ware@fortsillapache-nsn.gov

Mr. Michael Darrow

Tribal Historian michael.darrow@fortsillapache-nsn.gov

KIOWA TRIBE

Post Office Box 369 Carnegie, Oklahoma 73015

Chairman Lawrence SpottedBird

lspottedbird@kiowatribe.org

Amanda Hill

Tribal Historic Preservation Officer ahill@kiowatribe.org thpo@kiowatribe.org



MESCALERO APACHE TRIBE

Post Office Box 227 Mescalero, NM 88340

Ms. Holly Houghten

Tribal Historic Preservation Officer Mescalero Apache Tribe

TONKAWA

1 Rush Buffalo Road Tonkawa, OK 74653

Ms. Lauren Norman-Brown

Tribal Historic Preservation Officer lbrown@tonkawatribe.com

Mr. Russell Martin

President rmartin@tonkawatribe.com

• WHITE MOUNTAIN APACHE TRIBE

Post Office Box 507 Fort Apache, AZ 85926

Mr. Mark Altaha

Tribal Historic Preservation Officer MarkAltaha@wmat.us

WICHITA AND AFFILIATED TRIBES (WICHITA, KEECHI, WACO & TAWAKONIE)

P.O. Box 729 Anadarko, OK 73005

Ms. Terri Parton

President Terri.Parton@wichitatribe.com

YSLETA DEL SUR PUEBLO - TIGUA

119 South Old Pueblo Drive El Paso, TX 79907

Mr. Evaristo Cruz

Environmental Manager ecruz@ydsp-nsn.gov